RUST MANOR

INTERIOR RENOVATIONS

802 CHILDRENS CENTER RD LEESBURG, VA 20175

OWNER

NORTHERN VIRGINIA REGIONAL PARK AUTHORITY

SHEET NAME

ELECTRICAL

ELECTRICAL

NOTES AND SYMBOLS - ELECTRICAL

NEW LIGHTING PLAN - ELECTRICAL

NEW POWER PLAN - ELECTRICAL

RISER DIAGRAM AND SCHEDULES -

DEMOLITION LIGHTING PLAN -

DEMOLITION POWER PLAN -

NOTES AND SYMBOLS -

FLOOR PLANS - MECHANICAL

NOTES AND SYMBOLS - PLUMBING

DEMOLITION PLANS - PLUMBING

SANITARY, VENT & DOMESTIC

RISER DIAGRAMS - PLUMBING

SCHEDULES AND DETAILS -

PLUMBING

WATER PLANS - PLUMBING

ELECTRICAL

E100

E200

E201

E202

M100

PLUMBING

P100

PD100

P101

P102

P103

MECHANICAL

5400 OX RD FAIRFAX STATION, VA 22039 **CONTACT: JAKE BUMBREY** 703-359-4620



ARCHITECT

MAGINNISS + DEL NINNO ARCHITECTS

500 MONTGOMERY STREET, SUITE 550 ALEXANDRIA, VIRGINIA 22314 CONTACT: THERESA DEL NINNO, AIA 703-548-0460



MEP ENGINEER

GILL ENGINEERING GROUP, PLC

9161 LIBERIA AVENUE, SUITE 204B MANASSAS, VIRGINIA, 20110 CONTACT: HIRDAY GILL, PE 703-943-7106

DRAWING SHEET INDEX

BUILDING CODE COMPLIANCE PLANS

TOILET ROOM DETAILS & ADA

FIRST FLOOR DEMOLITION PLAN

FIRST FLOOR DEMOLITION RCP

OVERALL FIRST FLOOR PLAN

DOOR SCHEDULE AND DETAILS

FINISH SCHEDULE AND DETAILS

SHEET NAME

COVER SHEET

ADA DETAILS

ADA DETAILS

MOUNTING HEIGHTS

EQUIPMENT PLAN

FIRST FLOOR RCP

PARTITION TYPES

INTERIOR ELEVATIONS

SHEET NO.

GENERAL

G100

G101

G200

G201

G202

D100

D101

A100

A101

A200

A400

A600

A601

A602

DEMOLITION

ARCHITECTURAL



SHEET NAME

DEMOLITION PLAN

FIRE ALARM NOTES SYMBOLS AND

NEW FIRE ALARM DEMOLITION PLAN

FIRE PROTECTION

GENERAL NOTES:

GENERAL NOTES APPLICABLE TO ALL DRAWINGS - ITEMS AND CONDITIONS DETAILED, NOTED OR OTHERWISE IDENTIFIED ON ONE OF THE SECTIONS OR DETAILS ARE APPLICABLE TO ALL OTHER SECTIONS AND DETAILS OR SIMILAR

- ALL CONSTRUCTION AND WORK SHOWN ON THE COMPLETE SET OF
- MORE STRINGENT AND MORE COSTLY REQUIREMENT SHALL APPLY. ITEMS INSTALLED BY THE CONTRACTOR, EVEN IF NOT SHOWN IN THE IN THE SPECIFICATIONS, PROVIDE ITEM OF A QUALITY LEVEL CONSISTENT WITH THE GENERAL QUALITY LEVEL OF THE CONTRACT REQUIREMENTS. ATTENTION OF THE ARCHITECT IMMEDIATELY.
- WRITTEN INFORMATION TAKES PRECEDENT OVER DRAWINGS. BRING CONFLICTS BETWEEN WRITTEN INFORMATION AND DRAWN LINES TO THE ATTENTION OF THE ARCHITECT IMMEDIATELY.
- . IF A CONFLICT EXISTS BETWEEN DRAWINGS OF DIFFERENT SCALES. CONSULT THE ARCHITECT FOR CLARIFICATION.

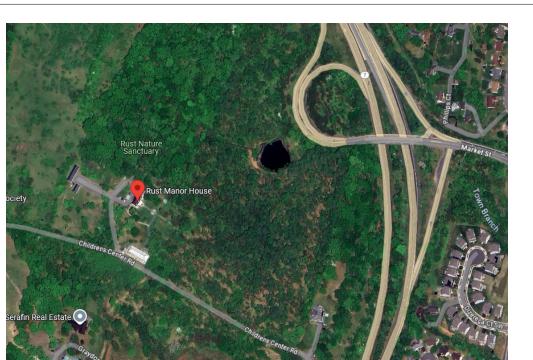
IN CASE OF DISCREPANCY OR ABSENCE OF DIMENSION, CONSULT THI

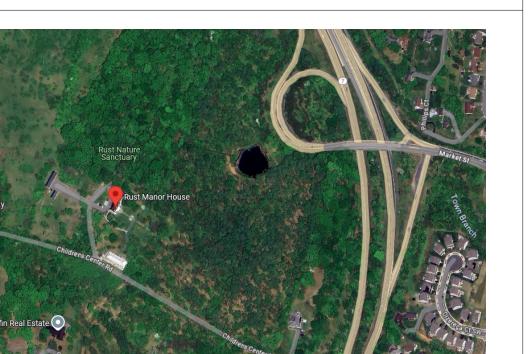
- 5. ALL DIMENSIONS SHOWN ARE DIMENSIONED TO FINISH FACE OF WALL U.N.O. SEE WALL TYPES SHEET FOR WALL CONSTRUCTION AND MATERIAL THICKNESS. IF A QUESTION OR DISCREPANCY REGARDING A DIMENSION OCCURS, REQUEST CLARIFICATION FROM THE ARCHITECT.
- ARCHITECT FOR CLARIFICATION. APPLICABLE CONDITIONS EVEN IF NOT SPECIFICALLY SHOWN OR REFERENCED. ANY SPECIFIC QUESTIONS CONCERNING CONSTRUCTION
- (C.J.) AND EXPANSION JOINTS (E.J.) IN EXTERIOR MASONRY WALLS. IF A CONFLICT EXISTS BETWEEN JOINT LOCATIONS SHOWN ON THE ELEVATIONS
- FLASHING AT THE BOTTOM OF THE CAVITY WITH WEEP HOLES TO THE OUTSIDE. ALL FLASHING BUILT INTO WALLS SHALL BE LAPPED AND SEALED. REFER TO FLASHING DETAILS INDICATED. 12. REFER TO BUILDING ELEVATIONS AND ELEVATION DETAILS FOR PATTERNS

- SHELVING. GATES AND OTHER INSTALLATIONS PRIOR TO SHOP OR FACTOR) FABRICATION, PROVIDE FINISHES AND TRIM INCLUDING BUT NOT LIMITED TO
- INTERIOR AND EXTERIOR CONDITIONS.
- 18. CONTRACTORS SHALL REFER TO MECHANICAL, PLUMBING AND ELECTRICAL DRAWINGS AND BE RESPONSIBLE FOR WORK ASSOCIATED TO THEIR PARTICULAR TRADE. CONTRACTORS SHALL COORDINATE THE WORK OF AMONG TRADES AND FIELD CHECK AGAINST CONFLICTS WITH DRAWINGS REPORT CONFLICTS TO THE ARCHITECT FOR CLARIFICATION. GENERAL CONTRACTOR IS RESPONSIBLE FOR PROVIDING SUBCONTRACTORS WITH INFORMATION WITHIN CONSTRUCTION DOCUMENTS THAT COMPLEMENTS
- 19. REFER TO DRAWINGS FOR LOCATIONS AND DESCRIPTIONS OF ACCESS PANELS, LOUVER OPENINGS, VENTILATORS, GRILLES, VALVE CABINETS, FIRE DAMPERS OR OTHER APPURTENANCES AFFECTING WALLS, CEILINGS OR FLOORS. COORDINATE WITH ALL ASSOCIATED TRADES FOR THE COMPLETION OF THE WORK.
- 21. REFER TO MECHANICAL, PLUMBING AND ELECTRICAL DRAWINGS FOR LOCATIONS AND TYPES OF PADS TO BE PROVIDED BELOW OR AROUND
- 22. MOUNT ELECTRIC SWITCHES, THERMOSTATS, AND OTHER ELECTRONIC CONTROLS LOCATED AT THE SAME VICINITY AND HEIGHT ABOVE FINISHED FLOOR IN A UNIFORM AND ORDERLY FASHION UNLESS OTHERWISE NOTED. THE MOUNTING HEIGHT SHALL BE 48" A.F.F. TO TOP OF BOX. ALL ELECTRICAL OUTLETS, TELEPHONE & DATA OUTLETS TO BE MOUNTED AT 24" A.F.F. TO CENTER OF BOX. TELEVISION MOUNTING HEIGHT TO BE 24" FROM CEILING OR 24" A.F.F. TO CENTER OF BOX. REFER TO ELECTRICAL DRAWINGS AND
- WITH BOTH SIDES OF THE EXISTING PARTITION AND HAVE SMOOTH CONFLICTS BETWEEN INDICATED WALL TYPE AND EXISTING WALL CONSTRUCTION TO THE ATTENTION OF THE ARCHITECT IMMEDIATELY.

- EACH TRADE AS APPROPRIATE FOR THE COMPLETION OF THE WORK.
- 20. WHERE REQUIRED, PROVIDE NECESSARY LINTELS, SUPPORT AND ANCHORAGE. REFER TO STRUCTURAL DRAWINGS AND FOR REQUIREMENTS.
- ARCHITECTURAL PLANS FOR OTHER HIGH OR LOW MOUNTINGS.
- 23. EXTERIOR SITE SHALL BE GRADED TO PROVIDE POSITIVE DRAINAGE AWAY FROM THE BUILDING EXTERIOR WALLS. PROVIDE EXTERIOR GRADE AT 8-INCH MINIMUM (U.N.O.) BELOW THE BUILDING FIRST FLOOR ELEVATION EXCEPT IN AREAS NEAR THE BUILDING ENTRANCE DOORS, U.N.O. PROVIDE EXPANSION AND CONTRACTION JOINTS AS REQUIRED. USE JOINT FILLER WHERE REQUIRED.
- 24. NEW PARTITIONS SHOWN AS INFILL SHALL BE CONSTRUCTED ALONG THE SAME PLANE AS THE EXISTING PARTITION INDICATED, AND SHALL ALLIGN TRANSITION FROM EXISTING TO NEW WORK. CONTRACTOR TO BRING ANY

VICINITY MAP






ARCHITECTURAL ABBREVIATIONS

ABV	ABOVE ABOVE FINISHED FLOOR	FEC	FIRE EXTINGUISHER CABINET	REF	REFERENCE
AFF AP	ACCESS PANEL	FLASH	FLASHING	RB	RESILIENT BASE
ACOUS	ACOUSTICAL	FLX	FLEXIBLE	RA	RETURN AIR
ACM	ASBESTOS CONTAINING MATERIAL	FL	FLOOR (ING)	REQ'D	REQUIRED
ACT	ACOUSTICAL TILE	FD	FLOOR DRAIN	REV	REVISION (S), REVISED
ADJ	ADJACENT	FTG	FOOTING	RD	ROOF DRAIN
ADJT	ADJUSTABLE	FDN GA	FOUNDATION GAGE, GAUGE	RDC	ROOF DRAIN CONDUCTOR
A/C	AIR CONDITIONING	GALV	GALVANIZED	RO	ROUGH OPENING
ALT	ALTERNATE ALUMINUM	GC	GENERAL CONTRACT (OR)	RTU	ROOF TOP UNIT
ALOW (AL) AB	ANCHOR BOLT	GLA	GLASS, GLAZING	SHT	SHEET
ANOD	ANODIZED	GB	GRAB BAR	SIM	SIMILAR
	APPROXIMATE	GWB	GYPSUM WALL BOARD	SIP	STRUCTURAL INSULATION PANELS
ARCH	ARCHITECT (URAL)	HDW	HARDWARE	SC	
BM BBC	BEAM	HP	HIGH POINT	SF	SOLID CORE
BRG BRG PL	BEARING BLATE	HVAC	HEATING/VENTILATING/AIR CO		SQUARE FEET
BLK (G)	BEARING PLATE BLOCK (BLOCKING)	HT HC	HEIGHT	SPEC	SPECIFICATION (S)
BD (O)	BOARD	HDPE	HOLLOW CORE	SQ	SQUARE
BLDG	BUILDING	HM	HIGH-DENSITY POLYETHYLENE HOLLOW METAL	SST	STAINLESS STEEL
CAB	CABINET	HORIZ	HORIZONTAL	STC	SOUND TRANSMISSION COEFFICIENT
CB	CEMENT BOARD	ID	INSIDE DIAMETER	STD	STANDARD
CPT CLG	CARPET (ED) CEILING	INSUL	INSULATE (D), (ION)	STL	STEEL
CEG	CERAMIC TILE	INT	INTERIOR	STO	STORAGE
CMU	CONCRETE MASONRY UNIT	JC	JANITOR'S CLOSET	STRUC	STRUCTURAL
COL	COLUMN	LL	LIVE LOAD	SUSP	
CONC	CONCRETE	LAB	LABORATORY		SUSPENDED
CONST CONT	CONSTRUCTION CONTINUOUS OR CONTINUE	LBS	POUNDS	TB	TACK BOARD
CJ	CONTROL JOINT	MB	MARKER BOARD	TEL	TELEPHONE
CL	CENTER LINE	MFR	MANUFACTURE (ER)	THK	THICKNESS
CORR	CORRUGATED	MAS	MASONRY	THRES	THRESHOLD
DL	DEAD LOAD	MO MAX	MASONRY OPENING MAXIMUM	TRTD	TREATED
DET	DETAIL	MECH	MECHANIC (AL)	T/SLB	TOP OF SLAB
DIA DIM	DIAMETER	MED	MEDIUM	TYP	TYPICAL
DIW DR	DIMENSION DOOR	MTD	MOUNTED	UL	UNDERWRITER'S LAB
DS	DOWNSPOUT	MTL	METAL	UNO	UNLESS NOTED OTHERWISE
DWG	DRAWING	MP	METAL PANEL	VERT	VERTICAL
ELEC	ELECTRIC (AL)	MIN	MINIMUM	VIF	VERIFY IN FIELD
EWC	ELECTRIC WATER COOLER	MISC	MISCELLANEOUS	VPB	VAPOR BARRIER
ELEV	ELEVATOR	MR	MOISTURE RESISTANT	VCT	VINYL COMPOSITION TILE
EMER	EMERGENCY	NRC NOM	NOISE REDUCTION COEFFICIENT NOMINAL	VPB	VAPOR BARRIER
EQ	EQUAL	NIC	NOT IN CONTRACT	WWF	WELDED WIRE FABRIC
EQUIP	EQUIPMENT	NTS	NOT TO SCALE	WIN	WINDOW
ETR	EXISTING TO REMAIN	OC	ON CENTER (S)	W/	WITH
EX	EXPOSED	OPNG	OPENING	W/O	WITHOUT
EXH	EXHAUST	OPP	OPPOSITE	WD	WOOD
EXIST EB	EXISTING EXPANSION BOLT	OD	OUTSIDE DIAMETER	WP	WATER PROOFING
EJ	EXPANSION JOINT	PTD	PAINT (ED)	WPT	WORKING POINT
EXPD	EXPOSED	PNB	PANIC BAR	WR	WATER RESISTANT
EXT	EXTERIOR	PTN	PARTITION		
F/CONC	FACE OF CONCRETE	PL	PLATE		
F/FIN	FACE OF FINISH	PLAM	PLASTIC LAMINATE		
F/MAS	FACE OF MASONRY	PLYWD	PLYWOOD		
F/STUDS	FACE OF STUDS	PRT	PRESERVATIVE TREATED		
FCU	FAN COIL UNIT	PVC	POLYVINYL CHLORIDE		
FIN	FINISH (ED)	QT	QUARRY TILE		
FFL FF	FINISHED FLOOR LINE	RAD	RADIUS		
	FIRE EXHIVITALIINHER		· - -		

ARCHITECTURAL SYMBOLS

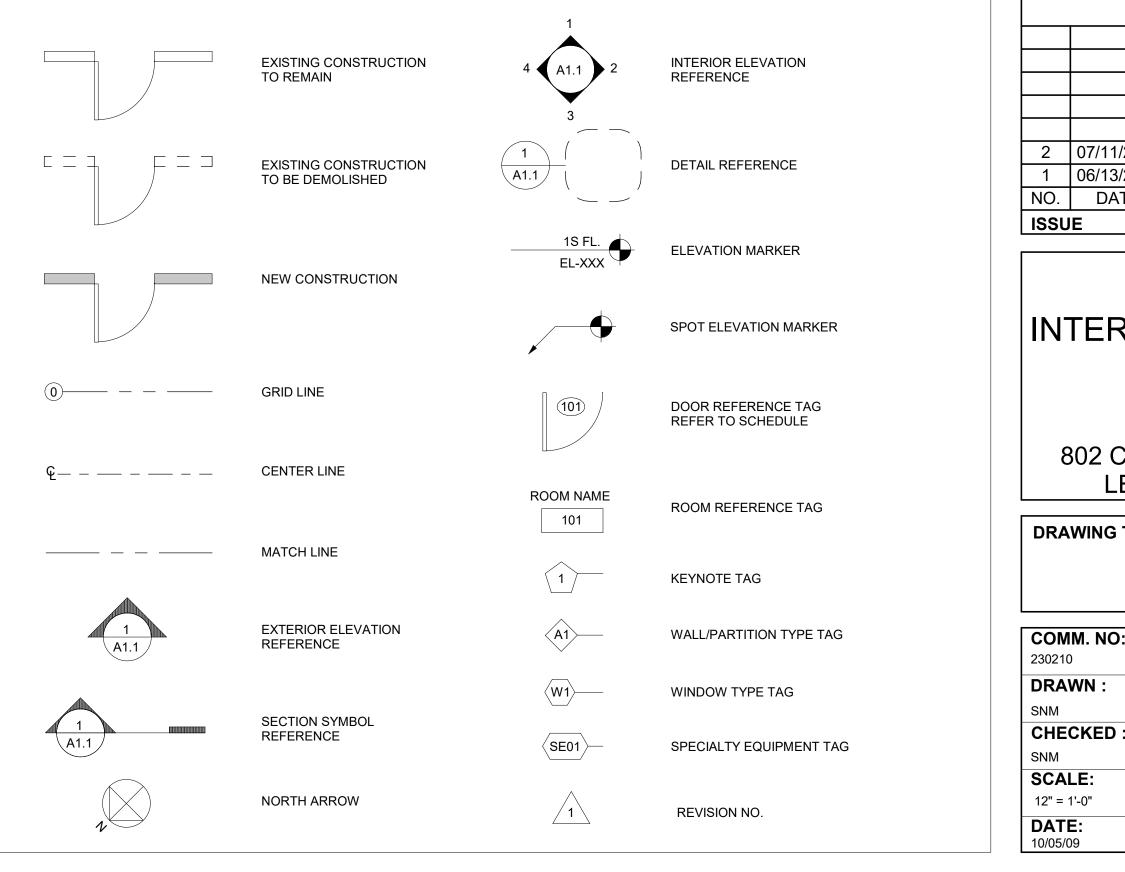FIRE EXTINGUISHER





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CONSTRUCTION DOCUMENTS DESIGN DEVELOPMENT 06/13/2025 NO. DATE DESCRIPTION ISSUE

RUST MANOR INTERIOR RENOVATIONS

802 CHILDRENS CENTER RD LEESBURG, VA 20175

DRAWING TITLE: **COVER SHEET**

10/05/09

I. NO:	DRAWING NUMBER:
/N :	

G100

BUILDING CODE ANALYSIS

PROJECT DESCRIPTION:

THE MODIFICATION OF EXISTING RESTROOMS TO MEET ADA REQUIREMENTS. THE RECONFIGURATION OF EXISTING BREAK ROOM INTO STORAGE. THE EXPANSION OF EXISTING PANTRY.

BUILDING CODES:

FIRE ALARM SYSTEM: NO

APPLICABLE CODE:

VIRGINIA EXISTING BUILDING CODE (IBC), 2021 2021 VIRGINIA CONSTRUCTION CODE 2021 ICC EXISTING BUILDING CODE ACCESSIBLE AND USABLE BUILDINGS AND FACILITIES (ICC/ANSI A117.1), 2017

GENERAL BUILDING CODE INFORMATION:

OCCUPANCY CLASSIFICATION: UNSEPARATED MIXED USE; A-3, B (NO CHANGE) OCCUPANTS: EXISTING (NO CHANGE) BUILDING HEIGHT: 3 STORIES CONSTRUCTION TYPE: V SPRINKLERS: NO

BUILDING GROSS AREA TABULATION: (TABLE 506.2)

EXISTING BUILDING AREA	RENOVATION AREA	TOTAL BUILDING AREA AFTER RENOVATION
8,000 SF	890 SF	8,000 SF (NO CHANGE)
		(15% ALTERATION LEVEL 2 ALTERATION)

FIRE RESISTANCE RATING FOR BUILDING ELEMENTS:

TYPE X, TABLE 601

	<u> </u>
PRIMARY STRUCTURAL FRAME:	0 HOUR
EXTERIOR BEARING WALLS:	0 HOUR
INTERIOR BEARING WALLS:	0 HOUR
NONBEARING WALLS & PARTITIONS, EXTERIOR	0 HOUR
NONBEARING WALLS & PARTITIONS, INTERIOR	0 HOUR
FLOOR CONSTRUCTION	0 HOUR
ROOF CONSTRUCTION	0 HOUR
CORRIDOR	0 HOUR

FINISHES:

(TABLE 803.13 INTERIOR WALL AND CEILING FINISH REQU	JIREMENTS BY OCCUPANCY)
EXIT ENCLOSURES AND EXIT PASSAGEWAYS:	CLASS B


CORRIDORS:	CLASS B
ROOMS AND ENCLOSED SPACES:	CLASS B

MEANS OF EGRESS:

-		MAX COMMON PATH OF TRAVEL (1006.2.1)	NUMBER OF EXITS (1006.3.3)	EXIT ACCESS TRAVEL DISTANCE (1017.2)	MINIMUM CORRIDOR WIDTH (1020.3)
	CODE REQUIRED	75' 0"	2	200' 0"	36"
	PROVIDED	23' 0"	3	52' 0"	44"

		AREA OF WORK OCCUP	PANCY SCHEDULE		
ROOM NO.	ROOM NAME	FUNCTION	OCCUPANT LOAD FACTOR	AREA	OCCUPANCY
100	HALLWAY			169 SF	
103	JANITOR CLOSET	ACCESSORY STORAGE	300 SF	29 SF	1
104	PANTRY	COMMERCIAL PANTRY	200 SF	314 SF	2
105	STORAGE	ACCESSORY STORAGE	300 SF	97 SF	1



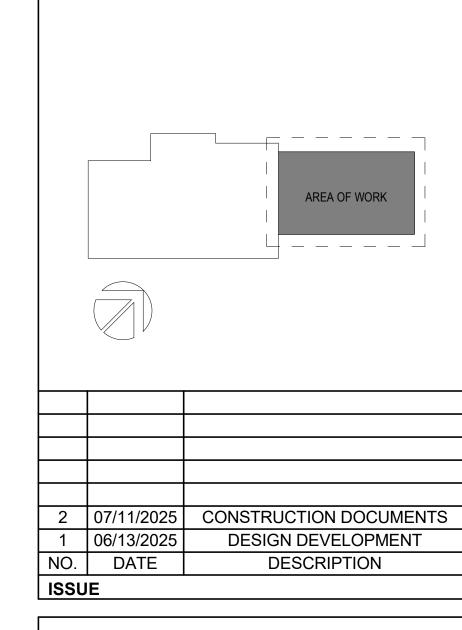






802 CHILDRENS CENTER RD LEESBURG, VA 20175


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SCALE:	1
As indicated	
DATE:	1
10/05/09	




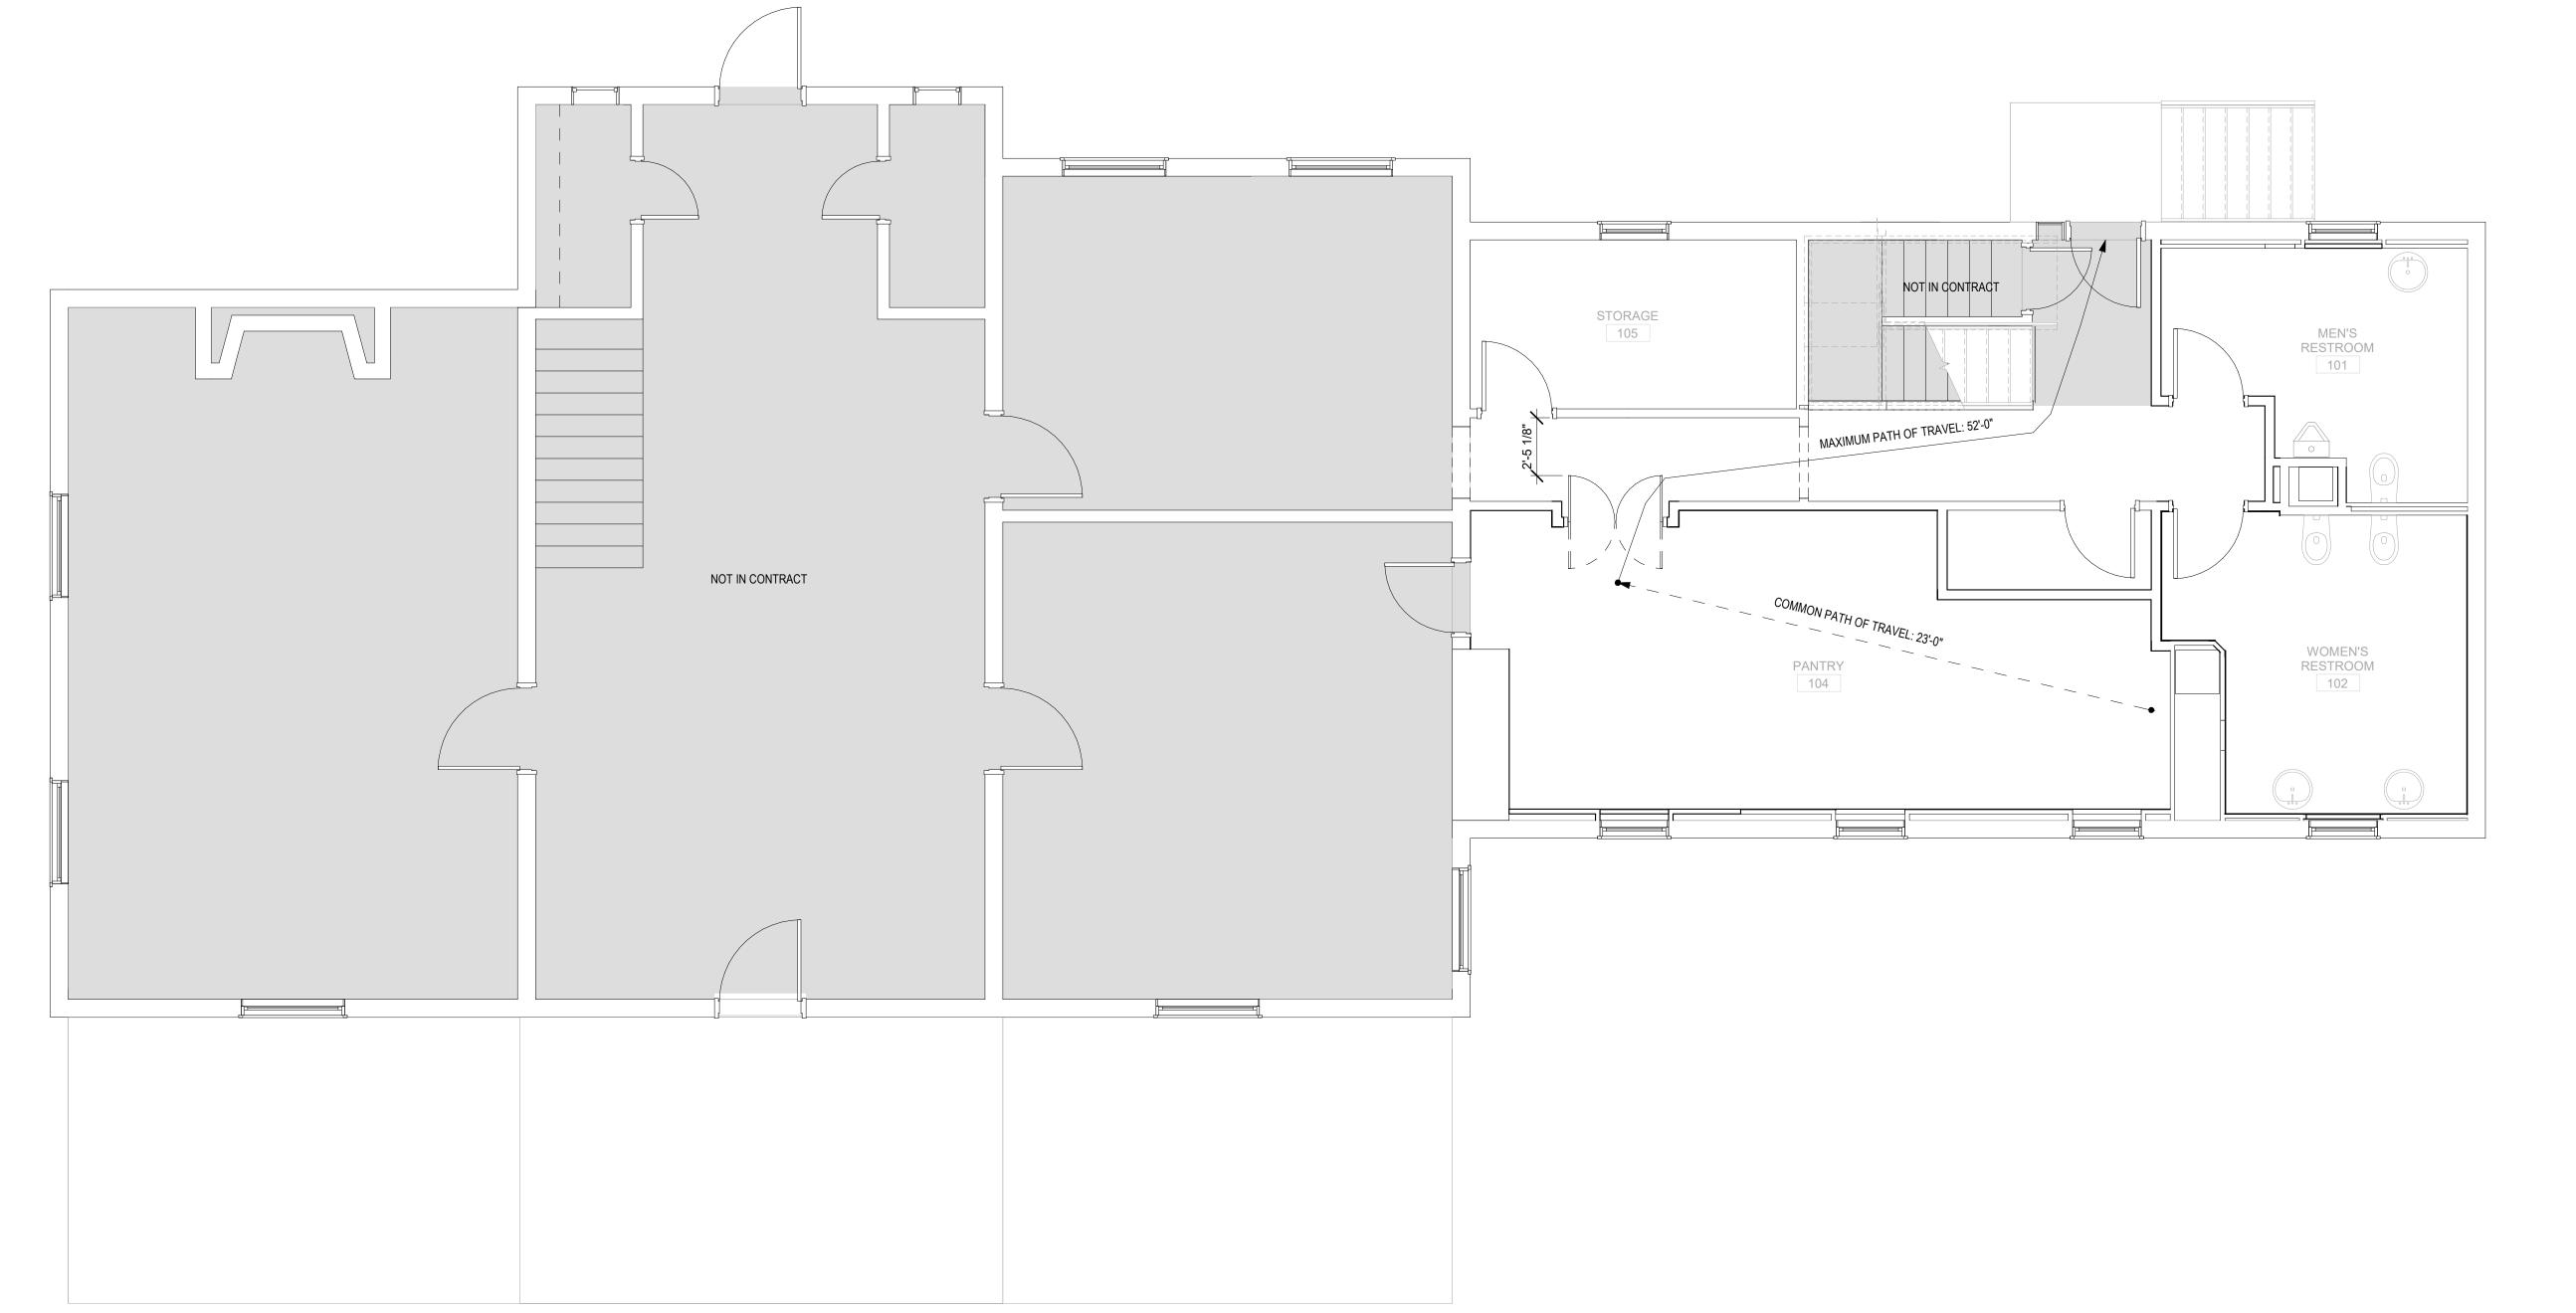

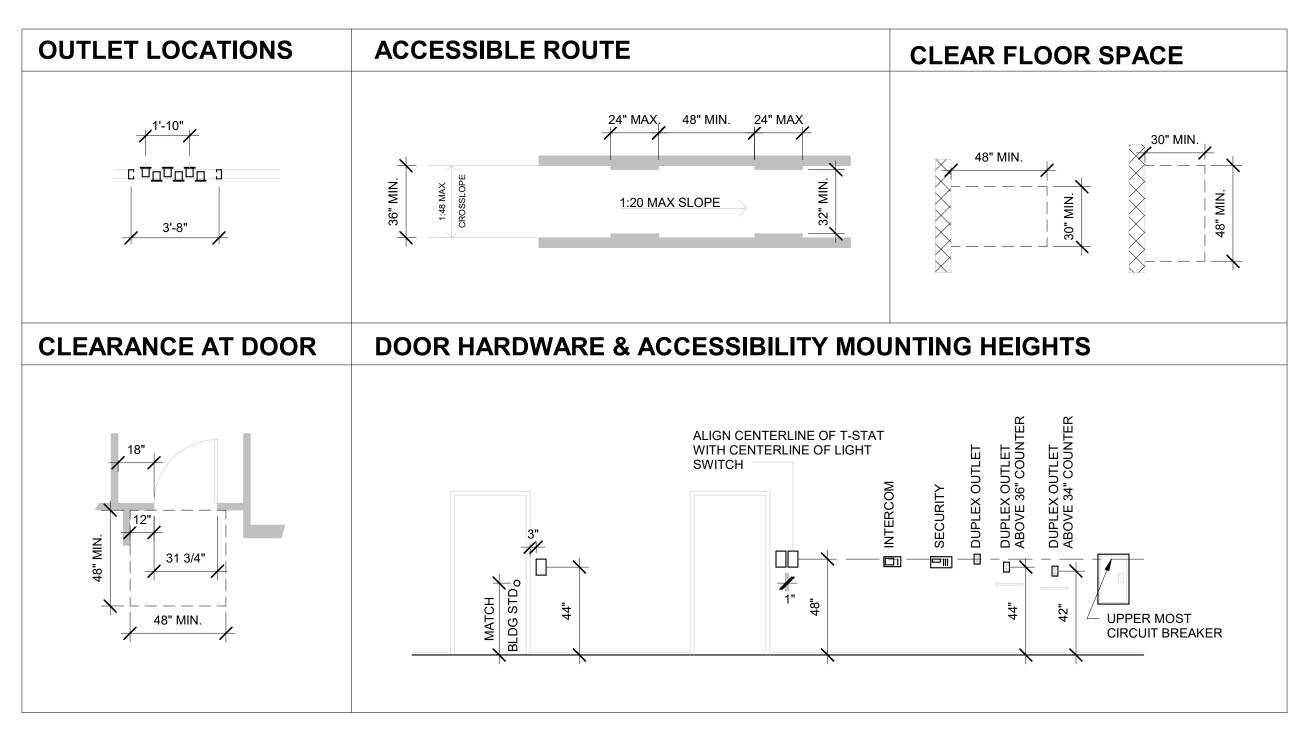

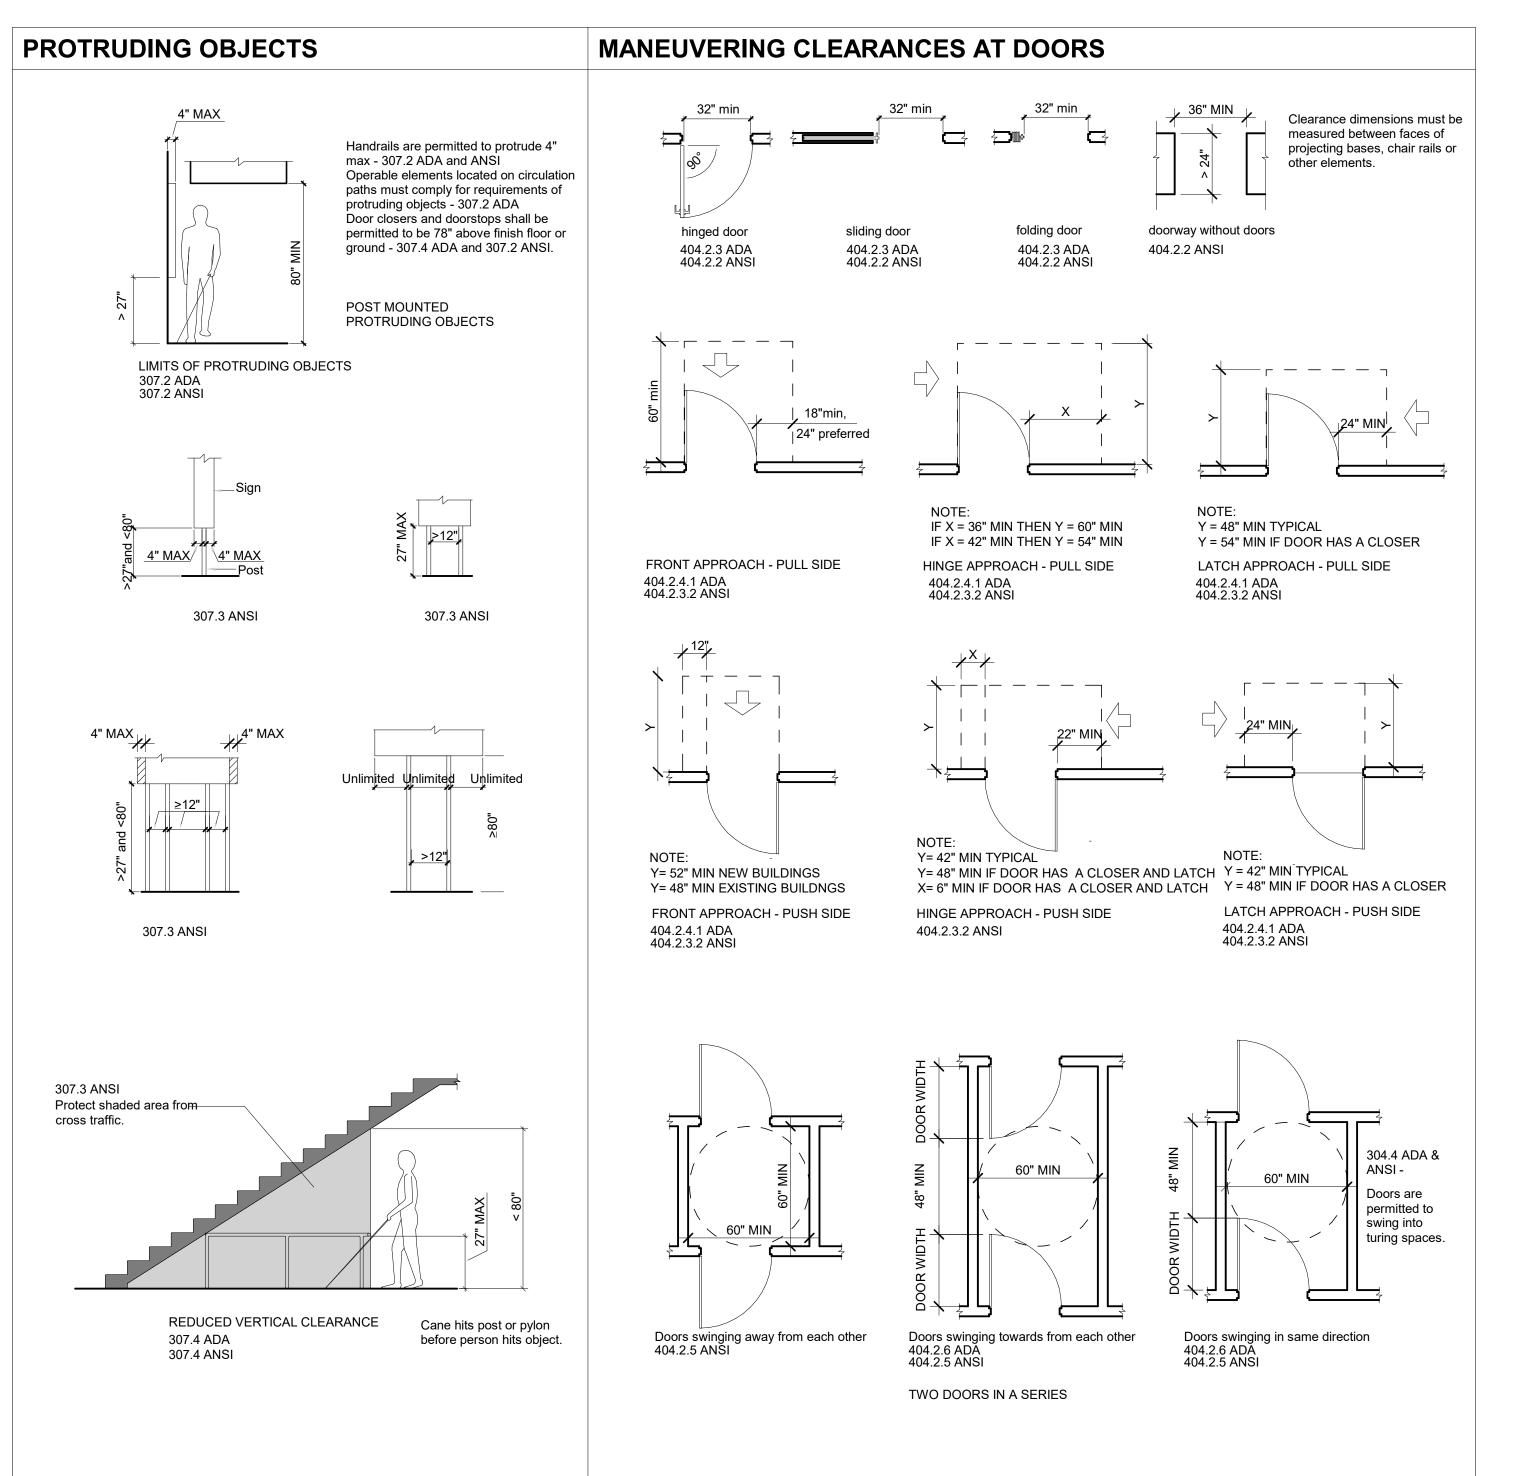

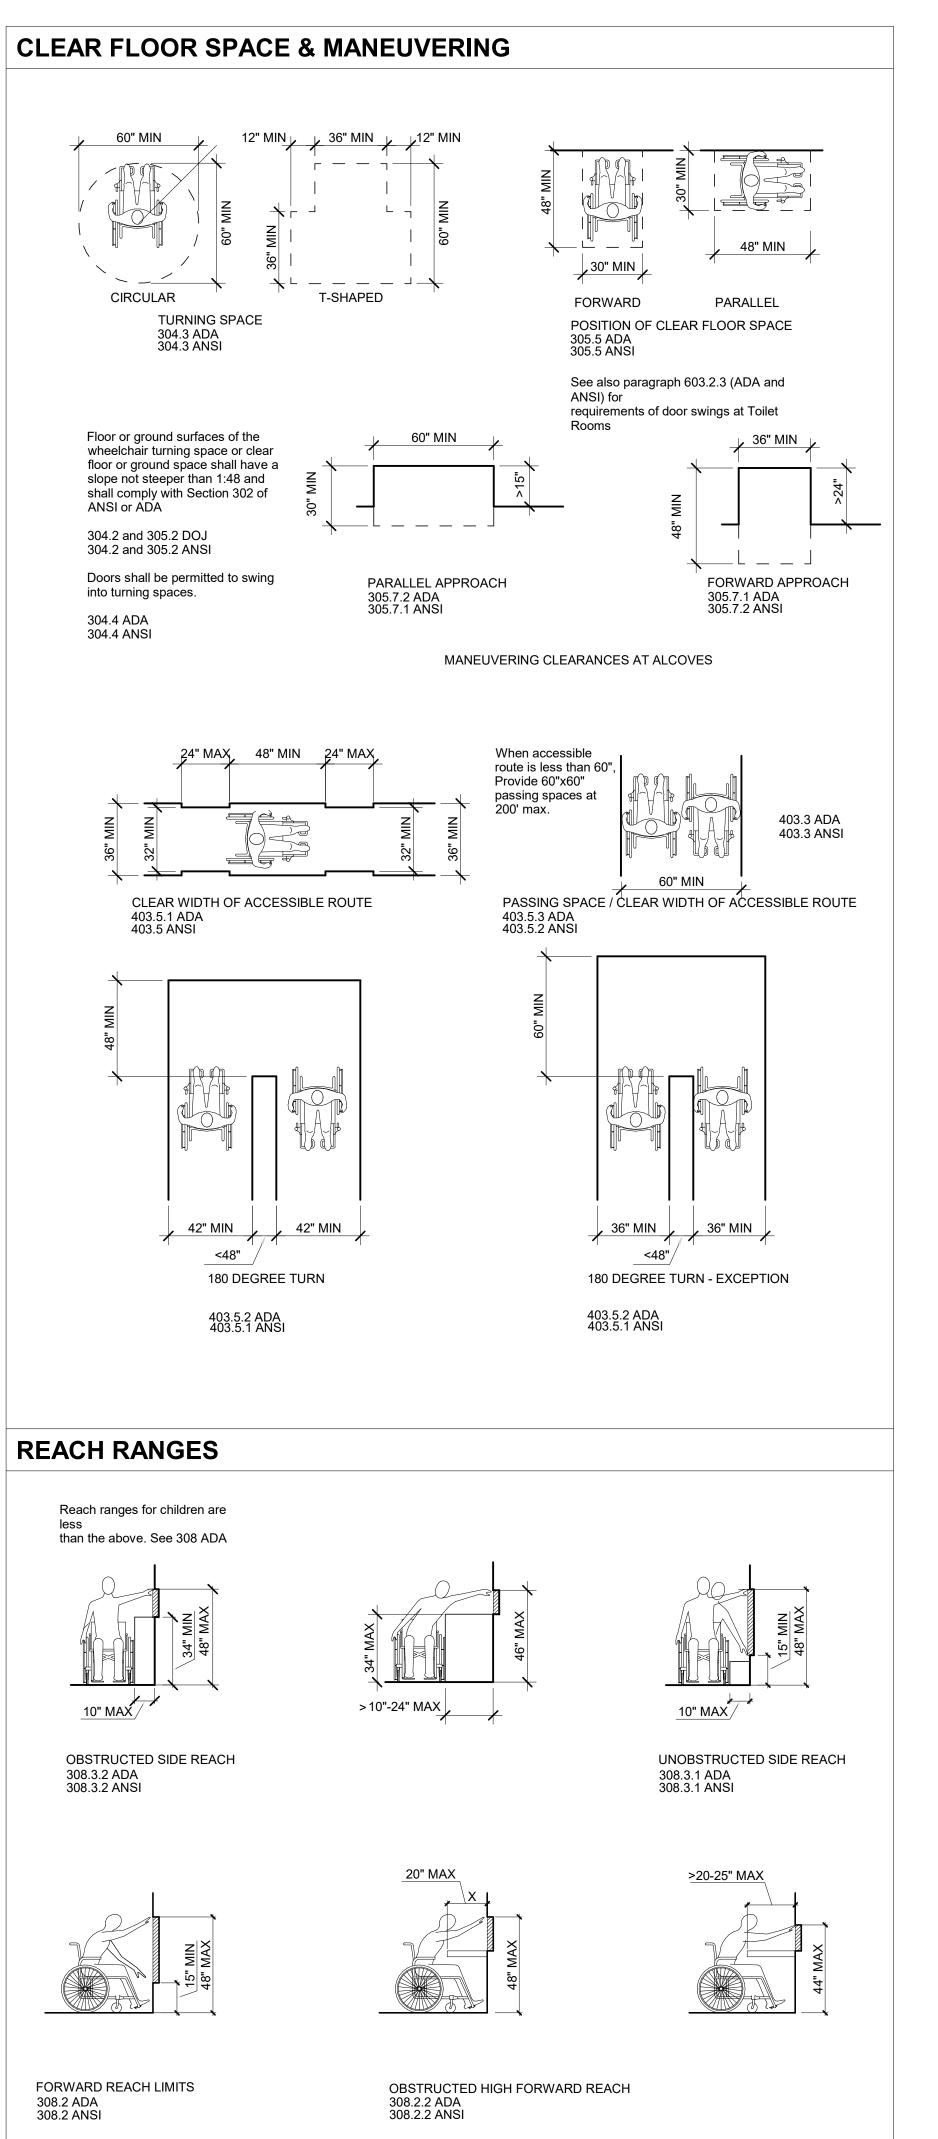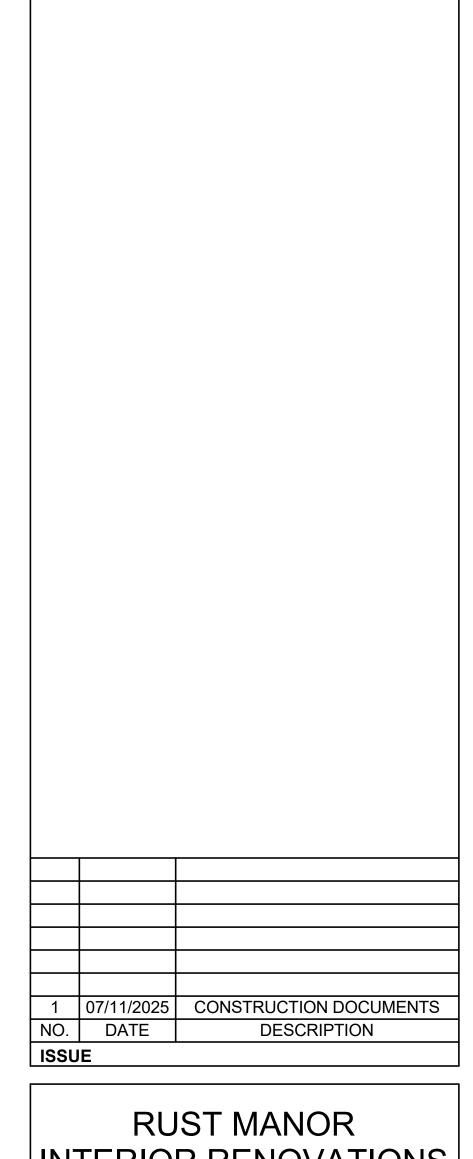



INTERIOR RENOVATIONS

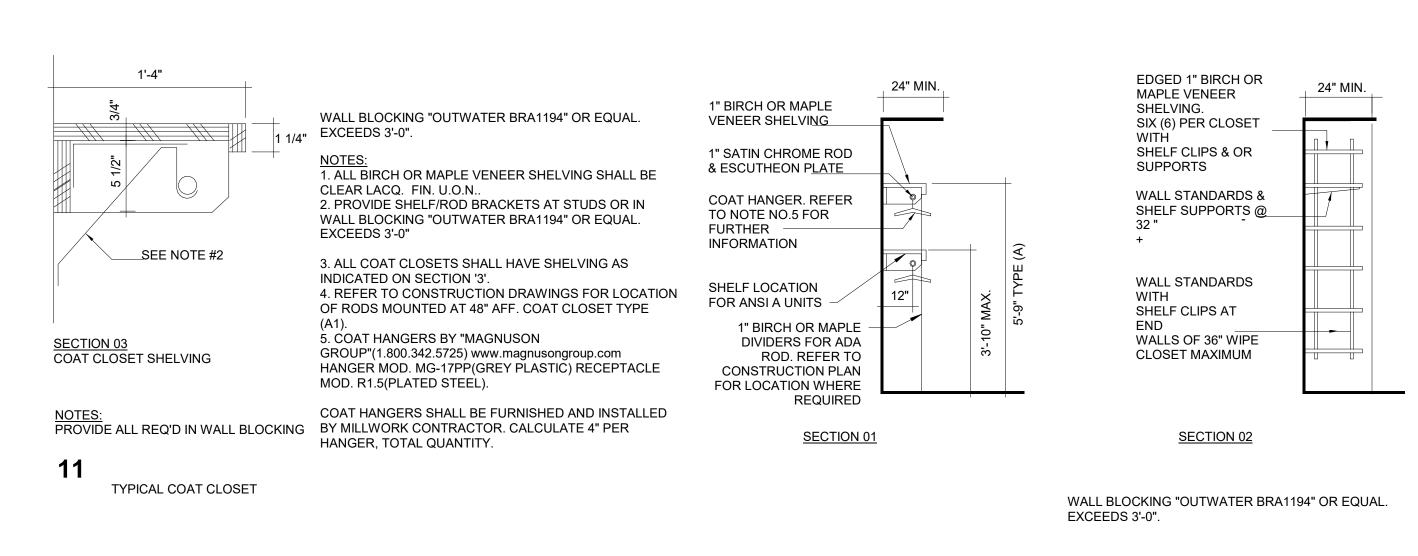
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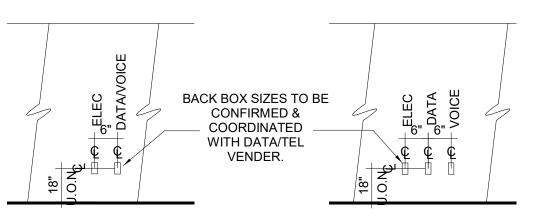
ADA DETAILS

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AQ	
CHECKED:	-
Checker	G200
SCALE:	
1/4" = 1'-0"	
DATE:	
10/05/09	

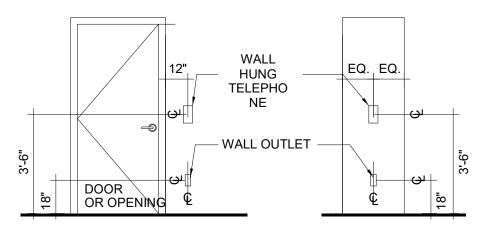
DEVICE LOCATION & ALIGNMENTS



DEVICE LOCATION & ALIGNMENTS




TYPICAL LOCATION FOR COMBINED OUTLETS AT VISIBLE AREAS (REFER TO GENERAL NOTE NO. 3 FOR FURTHER CLARIFICATION)




NOTE: (COORDINATE WALL OUTLET AT TELEPHONE)

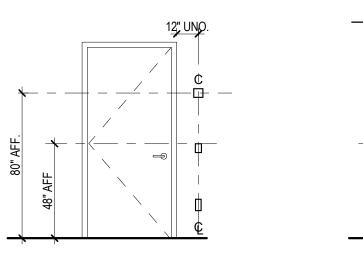
6 TYPICAL LOCATION FOR WALL HUNG TELEPHONE @ WALL OR COLUMN



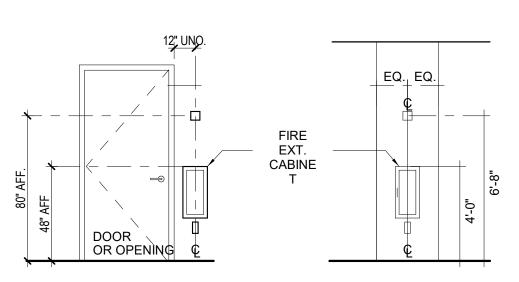
WALL OUTLET, FIRE ALARM DEVICE, PULL STATION



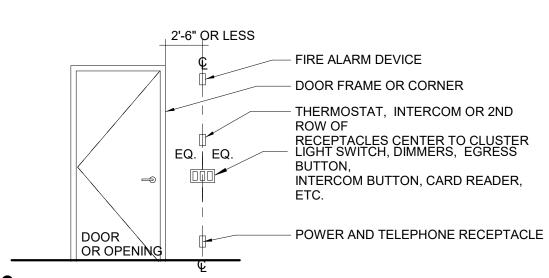8 WALL OUTLET, FIRE EXTINGUISHER CABINET, & FIRE ALARM DEVICE



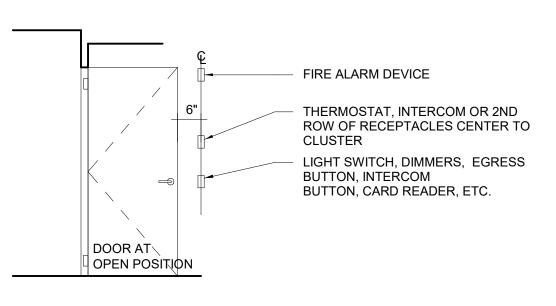9 WALL OUTLET, LIGHT SWITCHES, REQUEST TO EXIT BUTTONS, THERMOSTAT, FIRE ALARM DEVICE



WALL OUTLET, FIRE ALARM DEVICE, PULL STATION AT INTERIOR OFFICE OR CONF. ROOM

GENERAL NOTES:

RECESSED **PULLSTATION** 1. ALL DEVICES AND RECEPTACLES SHALL BE MOUNTED AS SPECIFIED ON THIS SHEET AND IN COMPLIANCE WITH ADA & CURRENT ICC/ANSI A117.1 (2009) GUIDELINES FOR UNLESS OTHERWISE NOTED. REFER TO POWER & COMMUNICATION PLAN(S) AND/OR ELEVATION(S). COORDINATE LOCATION OF OUTLETS WITH FINISH WALL PANEL JOINTS BEFORE SETTING.

2. OUTLETS IN GYPSUM BOARD/METAL STUD PARTITION. REFER TO FINISH PLAN(S) AND ELEVATION(S) FOR FURTHER INFORMATION. PROVIDE MATCHING COVER PLATES FOR ALL SYSTEMS. 3. ALL POWER AND TELEPHONE RECEPTACLES SHALL BE MOUNTED VERTICALLY EXCEPT WHEN:

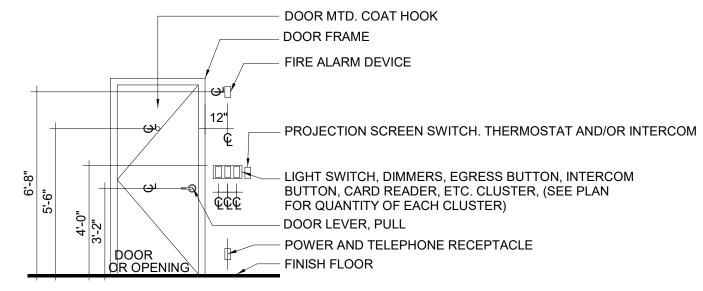
a) 3(THREE) OR MORE DUPLEX OUTLETS ARE GANGED TOGETHER WITH DUPLEX RECEPTACLES:




b) QUAD OUTLETS (OR SQUARE DATA/COMMUNICATION BOXES) ARE GANGED TOGETHER WITH DUPLEX RECEPTACLES




4. SUBMIT CUT-SHEET(S) OR SAMPLE OF ALL DEVICES, INCLUDING POWER AND COMMUNICATION RECEPTACLES, SWITCHES, PUSH BUTTONS, COVER PLATES, THERMOSTATS, HVAC DIFFUSERS, FIRE SAFETY DEVICES, EXIT SIGNS, ACCESS DOORS, WALL MOUNTED PHONES, ETC. TO ARCHITECT FOR REVIEW AND APPROVAL FOR AESTHETIC CONFORMITY.



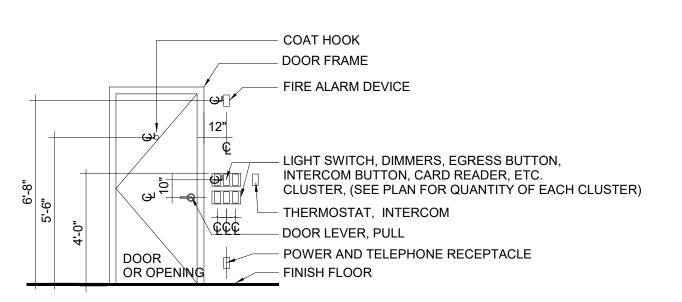
TYPICAL LOCATION FOR LIGHT SWITCHES, DIMMERS, EGRESS BUTTONS, THERMOSTATS, PROJECTION SCREEN SWITCHES, ETC.



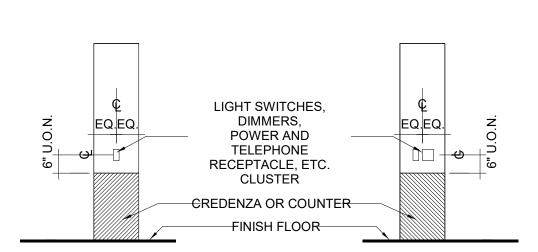TYPICAL LOCATION FOR TWO ROWS OF LIGHT SWITCHES, DIMMERS, EGRESS BUTTONS, THERMOSTATS, ETC.



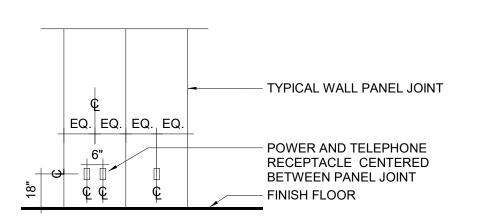TYPICAL LOCATION FOR OUTLETS, SWITCHES AND THERMOSTATS, ETC. AT CREDENZA OR COUNTERTOP (REFER TO GENERAL NOTE NO. 4 FOR FURTHER CLARIFICATION)



TYPICAL LOCATION FOR POWER AND TELEPHONE OUTLETS AT WALL PANEL OR COLUMN (REFER TO GENERAL NOTE NO. 4 FOR FURTHER CLARIFICATION)



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1 | 07/11/2025 | CONSTRUCTION DOCUMENTS NO. DATE DESCRIPTION ISSUE

RUST MANOR INTERIOR RENOVATIONS


802 CHILDRENS CENTER RD LEESBURG, VA 20175


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SCALE:	1


1/8" = 1'-0"

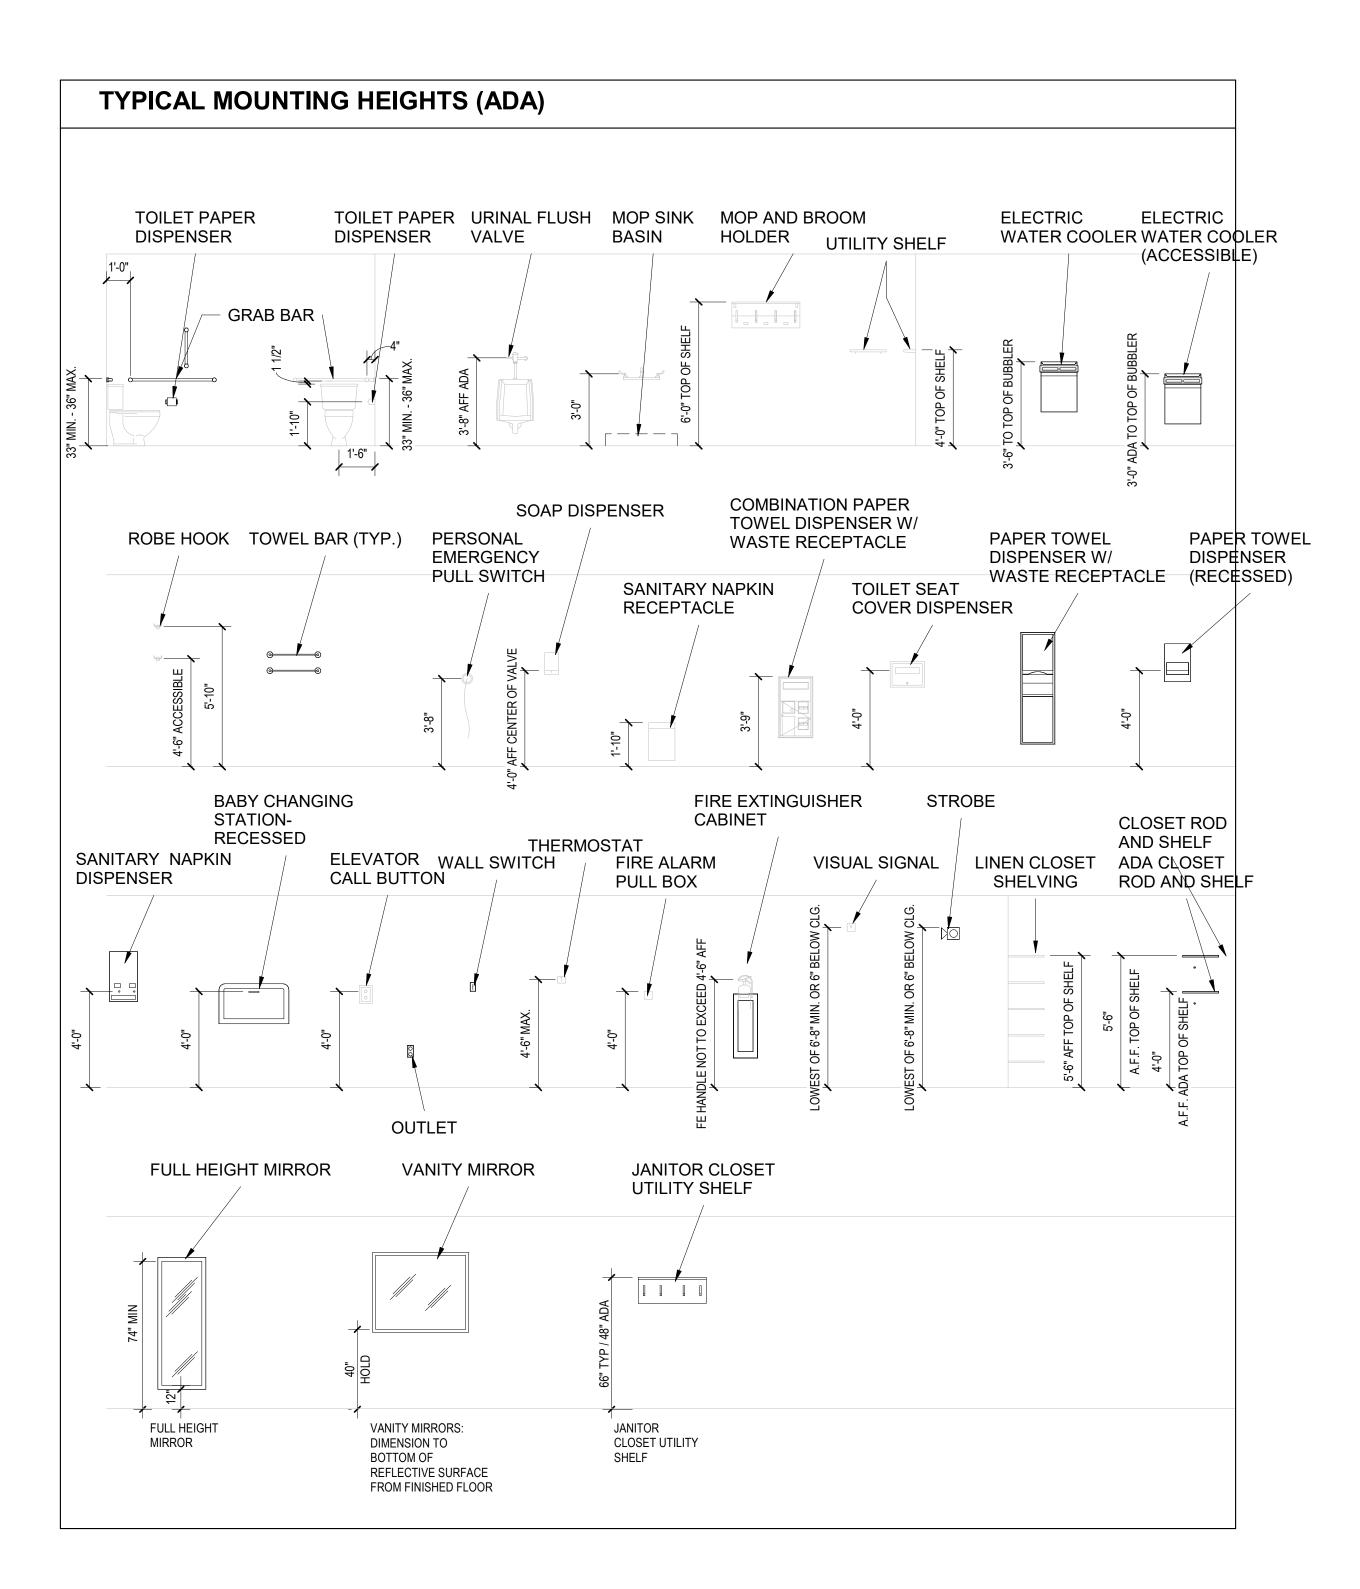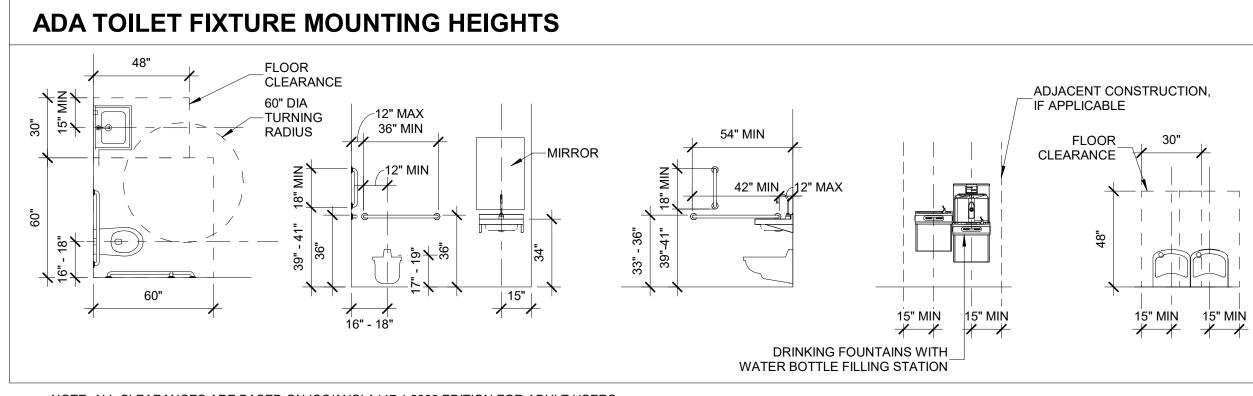DATE: 10/05/09





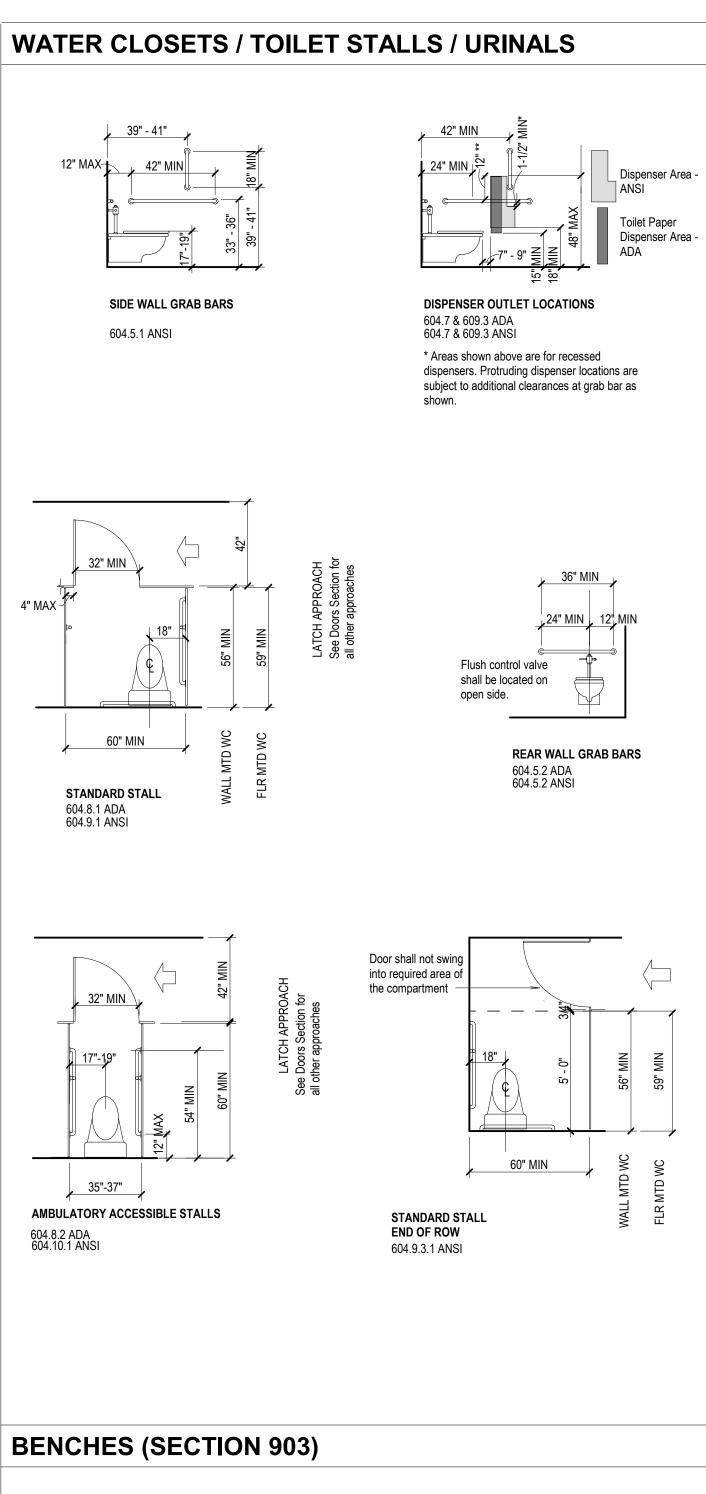NOTE: ALL CLEARANCES ARE BASED ON ICC/ANSI A117.1 2009 EDITION FOR ADULT USERS.



BENCH SIZE 903 ADA 903 ANSI

Urinals may be stall type or wall

hung with rim 17" above floor

May be reduced to 29" clear if screens do not project past front

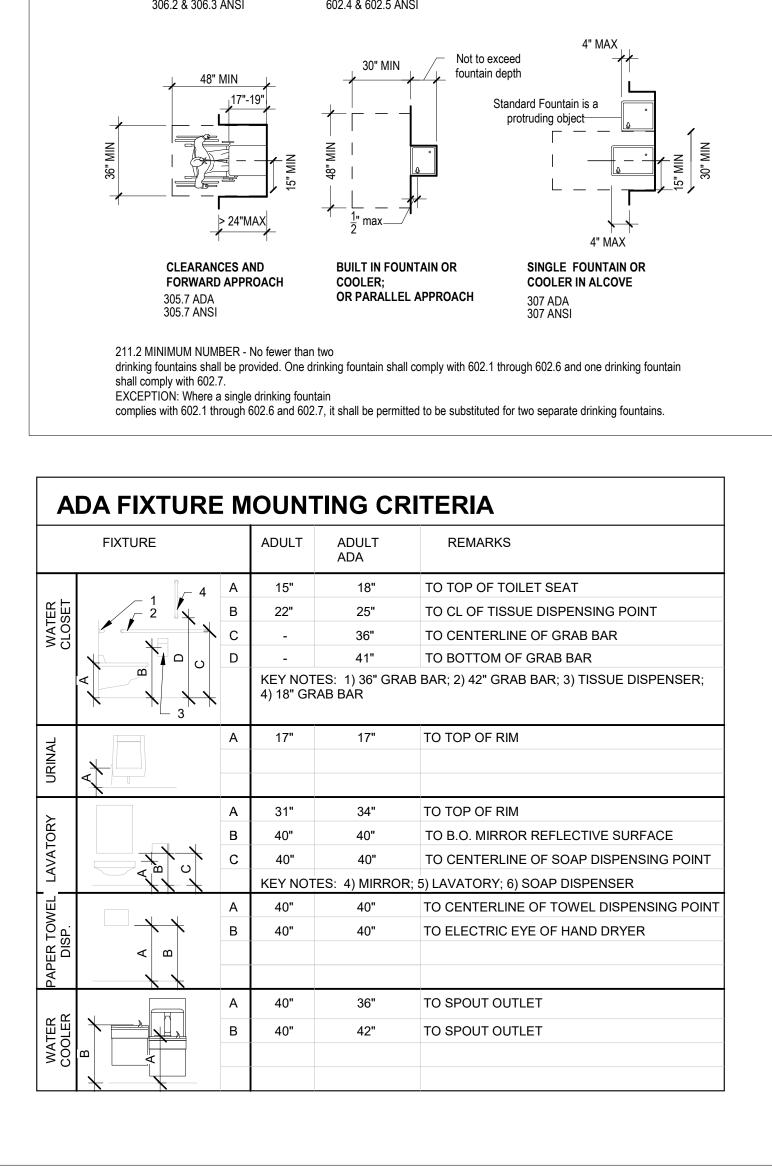
Must increase to 36" clear if screens are larger than 24" deep.

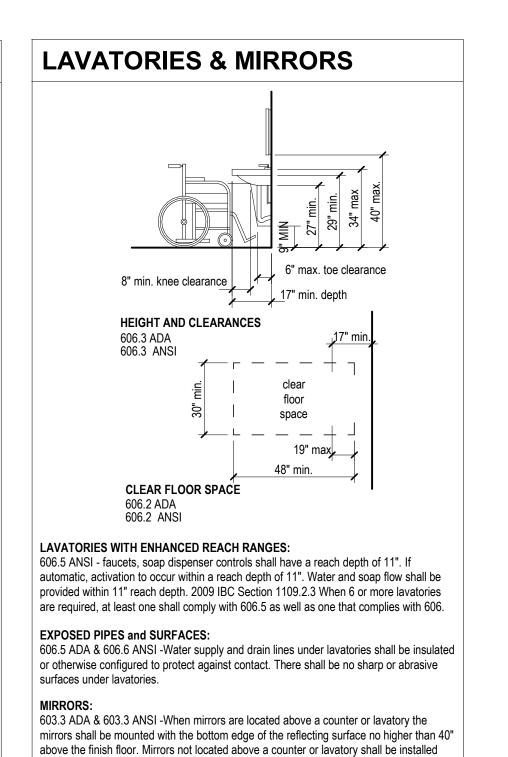
edge of urinal.

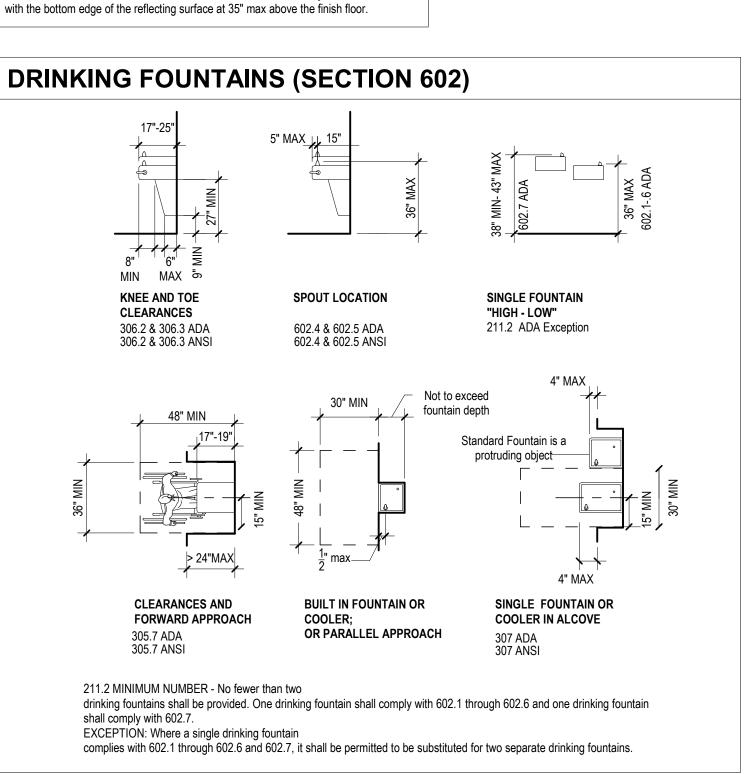
CLEAR FLOOR SPACE

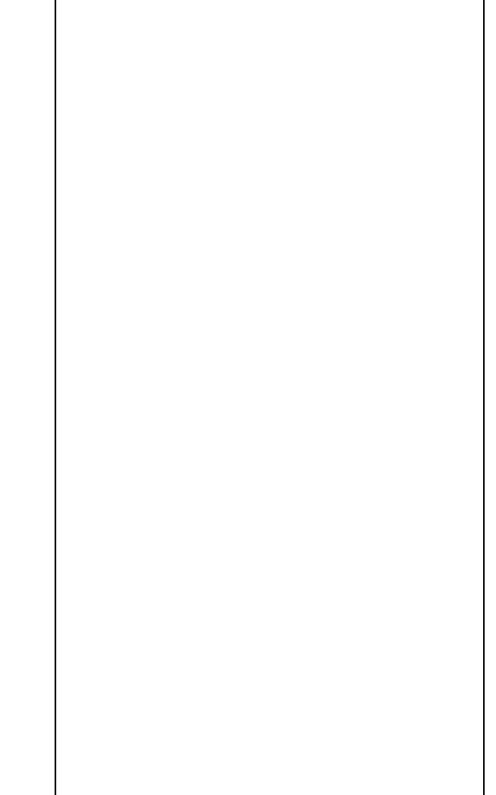
605.3 ADA 605.3 ANSI

URINALS (SECTION 605)









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RUST MANOR INTERIOR RENOVATIONS

1 | 07/11/2025 |

DATE

NO.

ISSUE

DATE: 10/05/09


CONSTRUCTION DOCUMENTS

DESCRIPTION

802 CHILDRENS CENTER RD LEESBURG, VA 20175

DRAWING TITLE: TOILET ROOM DETAILS & ADA MOUNTING HEIGHTS

COMM. NO: 230210	DRAWING NUMBER:
DRAWN:	
AQ	
CHECKED:	C202
Checker	G202
SCALE:	
1/4" = 1'-0"	

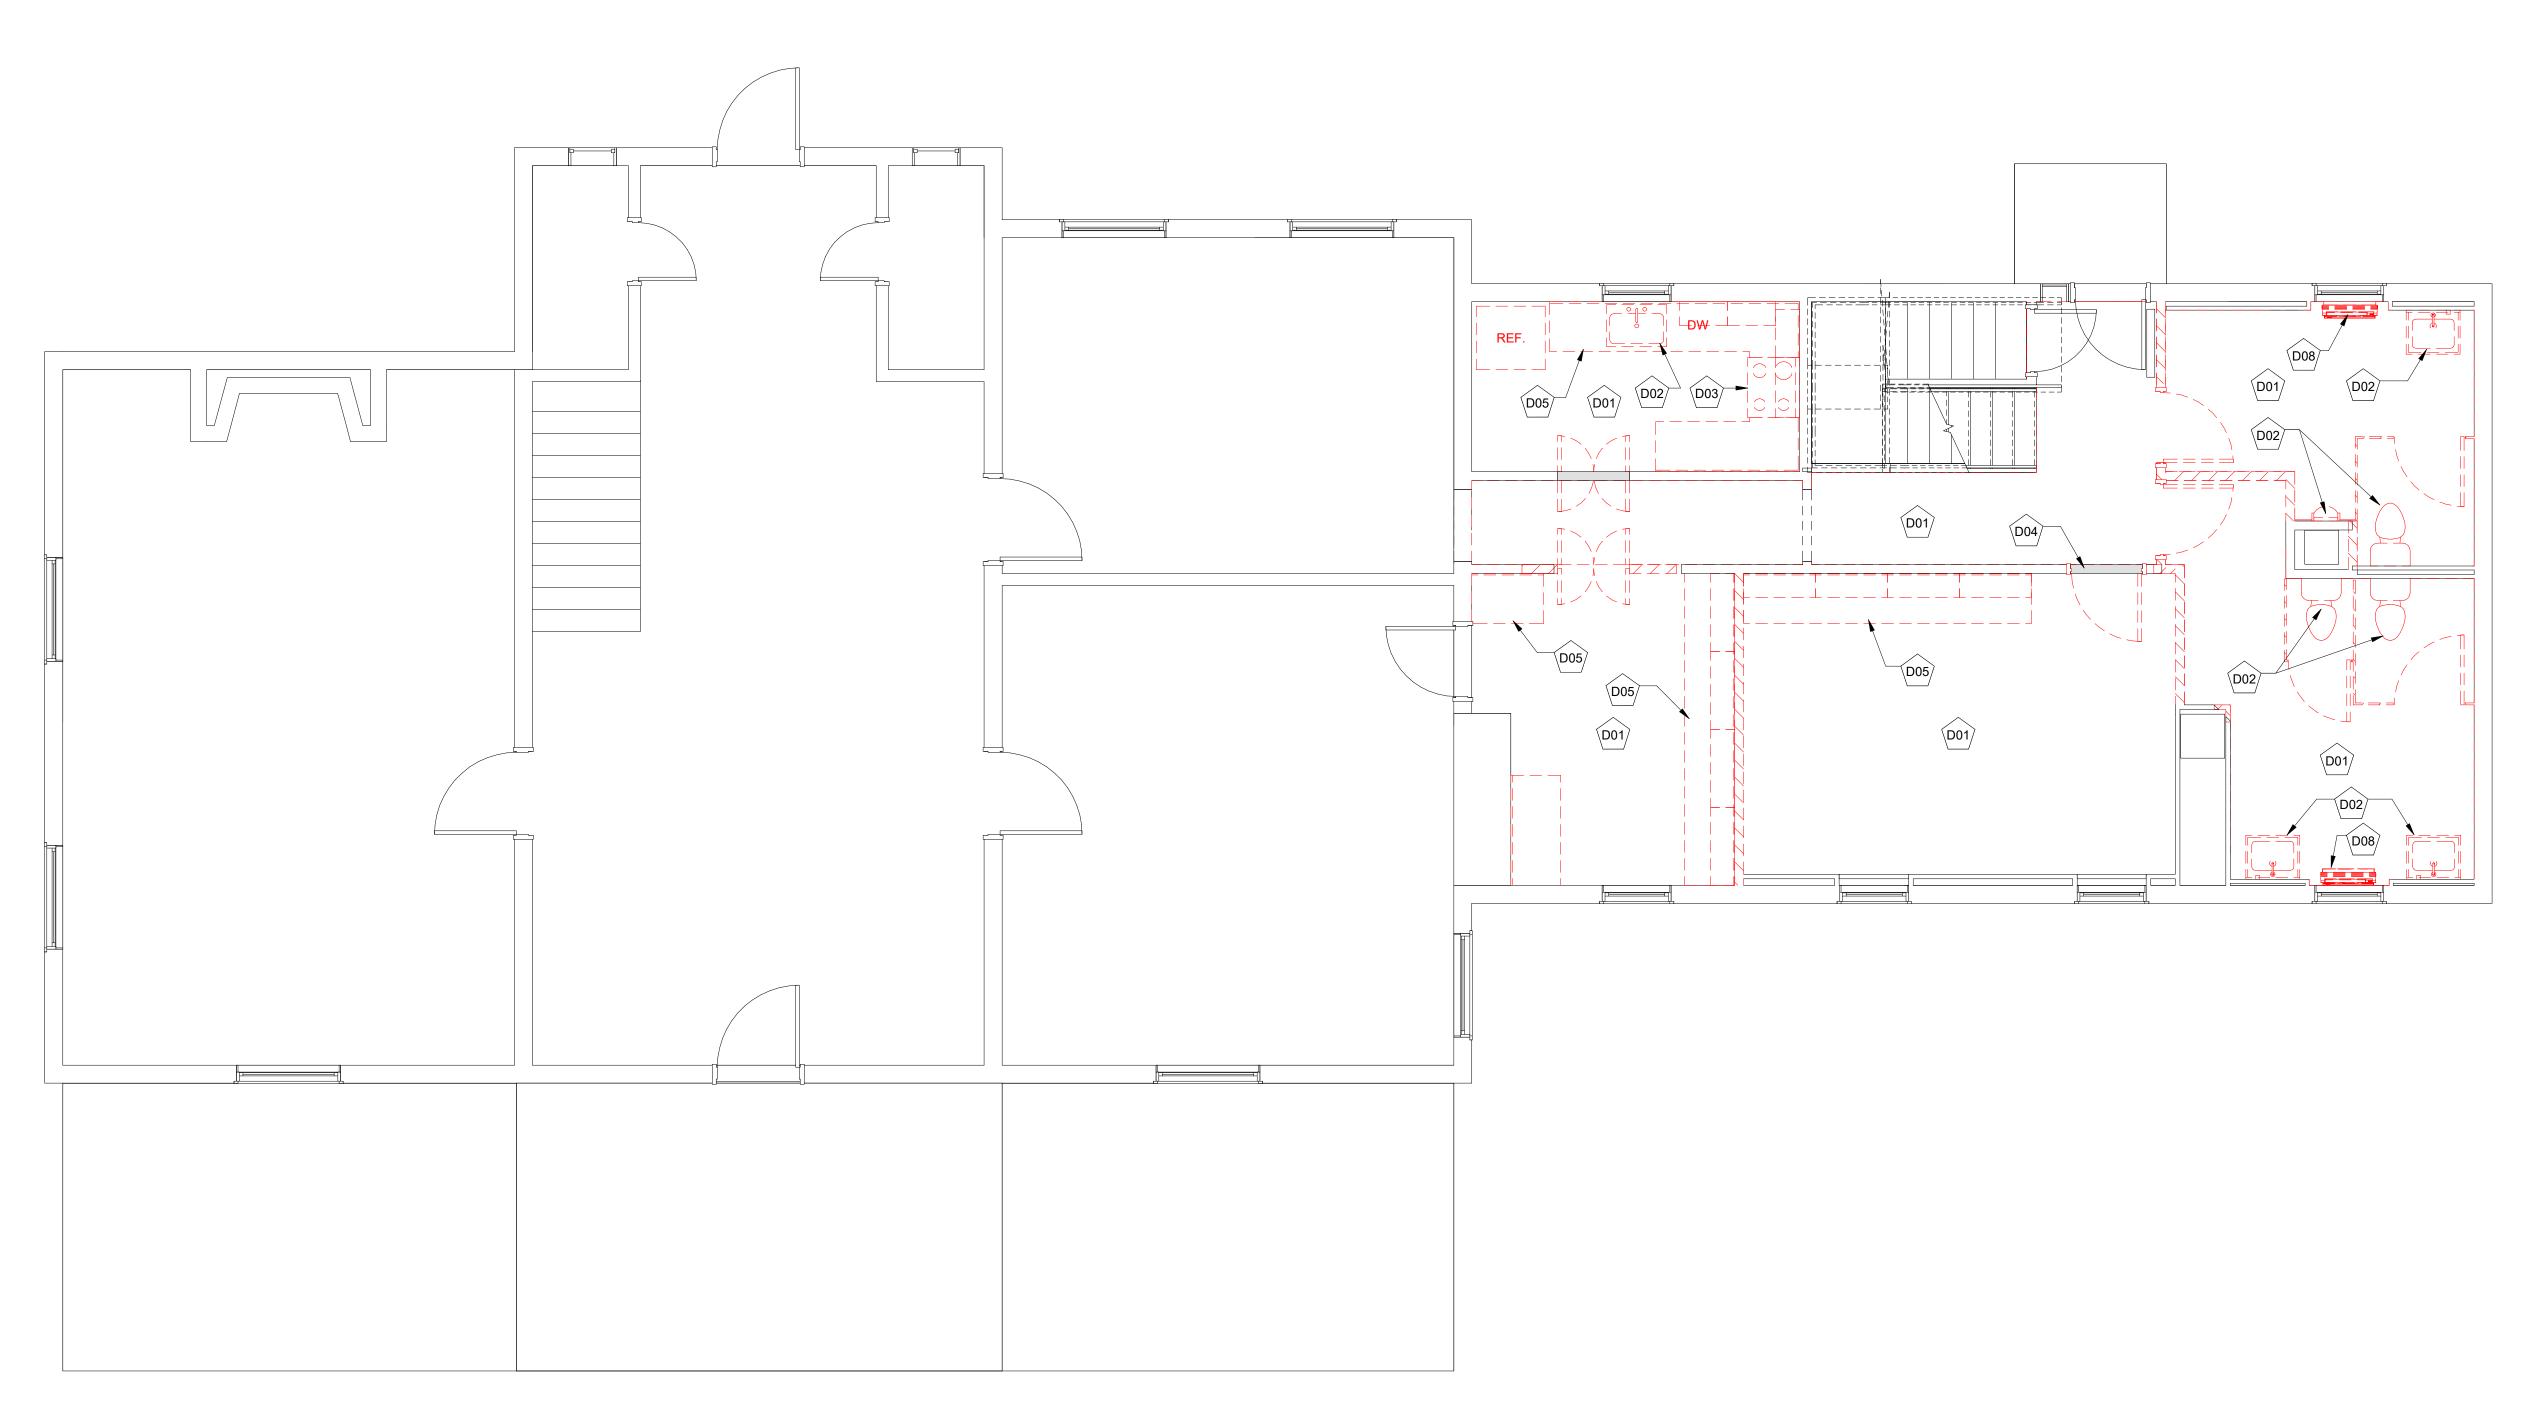



GENERAL DEMOLITION NOTES

- 1. ALL WORK SHOWN IS EXISTING TO REMAIN UNLESS NOTED OR INDICATED AS DASHED LINES TO BE REMOVED. THE EXTENT OF DEMOLITION WORK SHALL INCLUDE ALL INCIDENTAL DEMOLITION WORK NECESSARY TO PROPERLY PROVIDE ALL NEW WORK SHOWN AND SPECIFIED, TO INCLUDE MECHANICAL, ELECTRICAL, & PLUMBING ITEMS.
- ALL EXISTING STRUCTURE SHALL REMAIN, UNLESS NOTED OTHERWISE.
- 3. ALL EXISTING SURFACES TO REMAIN SHALL BE PROTECTED, PATCHED IF DAMAGED AND CLEANED PRIOR TO APPLICATION OF FINISHES. 4. CONTRACTOR TO PROTECT ALL EQUIPMENT AND OTHER ELEMENTS IN AREA OF NEW OR DEMOLITION WORK.
- 5. DEMOLITION WORK SHOWN IS BASED ON EXISTING DRAWINGS AND INSPECTIONS. THE CONTRACTOR SHALL VISUALLY INSPECT ALL EXISTING CONDITIONS, AND IS RESPONSIBLE FOR PERFORMING THE INDICATED DEMOLITION WORK EVEN IF ACTUAL CONDITIONS DIFFER FROM THESE SHOWN ON THE DRAWINGS.
- DEMOLITION CONTRACTOR SHALL COORDINATE WITH NEW WORK SECTIONS FOR ADDITIONAL INFORMATION RELATED TO EXTENT OF DEMOLITION.
- REFER TO ALL OTHER DRAWINGS IN THIS SET FOR INCIDENTAL DEMOLITION WORK NOT NOTED ON THE DEMOLITION PLANS. 8. THE OWNER HAS FIRST RIGHT OF REFUSAL OF ALL SALVAGE ITEMS. THE CONTRACTOR SHALL PROPERLY DISPOSE OF ALL CONSTRUCTION DEBRIS. DO NOT STOCKPILE DEBRIS ON SITE.
- 9. ITEMS TO BE DEMOLISHED SHALL BE REMOVED COMPLETELY INCLUDING ALL ANCHORS, HANGERS, FASTENERS, PIPES, CONDUITS, DUCTS, ETC. UNLESS OTHERWISE INDICATED TO BE ABANDONED IN PLACE.
- 10. CONC. SLAB PATCHES MUST BE FLUSH WITH REMAINING SURFACES TO PERMIT APPLICATION OF FINISHES. PROVIDE WELDED WIRE MESH IN PATCH AREAS LARGER THAN (4) FOUR SQUARE FEET. 11. CONCRETE SLABS TO REMAIN SHALL BE PATCHED, SCRAPED, LEVELED, AND CLEANED TO PROVIDE SURFACE SUITABLE FOR NEW FINISHES.
- 12. WHERE RENOVATED AREAS ARE RECEIVING NEW UNDERGROUND MECHANICAL, PLUMBING, ELECTRICAL, OR ADDITIONAL FOUNDATION WORK, SEE MECHANICAL, PLUMBING, ELECTRIC, AND STRUCTURAL DRAWINGS, AS WELL AS ARCHITECTURAL DRAWINGS TO DETERMINE EXTENT OF REQUIRED CUT AND PATCH OF EXISTING SLAB. CONTRACTOR IS RESPONSIBLE FOR PROVIDING ALL CONCRETE SLAB DEMOLITION AND REPLACE AS NECESSARY TO INSTALL THE NEW WORK. BACKFILL ALL BELOW GRADE DEMOLITION WORK WITH SUITABLE FILL MEETING STRUCTURAL REQUIREMENTS FOR NEW WORK.
- 13. CONTRACTOR SHALL CONFIRM PARTITIONS SHOWN TO BE REMOVED INCLUDING TYPE OF PARTITION AND EXACT LOCATION. COMPLETELY REMOVE PARTITIONS FROM FLOOR TO STRUCTURE ABOVE INCLUDING BASE, ALL FASTENERS, GROUTS, SEALANTS, ETC., UNLESS NOTED OTHERWISE. MASONRY PARTITIONS WHICH EXTEND THROUGH THE SLAB SHALL BE REMOVED TO 8" BELOW FINISH FLOOR. FILL SLAB OPENING WITH CONCRETE FILL TO RECEIVE FINISH FLOOR. WHERE WALLS SCHEDULED TO BE REMOVED SIT ON SLABS, GRIND SLAB TO RECEIVE FINISH FLOOR.
- 14. REMOVE, PATCH AND REPAIR PORTIONS OF WALL PARTITIONS WHICH CONFLICT WITH NEW WORK TO BE INSTALLED, EVEN IF NOT SPECIFICALLY NOTED TO BE DEMOLISHED ON PLANS. 15. COORDINATE DEMOLITION OF ALL STRUCTURAL ITEMS (COLUMNS, BEAMS, SLABS, ETC.) WITH STRUCTURAL DWGS. EXTENT OF DEMOLITION AREA SHALL BE IN ACCORDANCE WITH STRUCTURAL REQUIREMENTS
- 16. TEMPORARILY SUPPORT ALL BEAMS, LINTELS, PORTIONS OF WALLS ETC., TO BE DISTURBED BY DEMOLITION WORK, UNTIL THEY ARE RE-SUPPORTED BY NEW WORK. 17. CONTRACTOR SHALL BE RESPONSIBLE FOR MAINTAINING THE INTEGRITY OF EXISTING BUILDING ELEMENTS TO REMAIN THROUGHOUT SEQUENCE OF WORK. ANY DAMAGE TO EXISTING BUILDING CONDITIONS
- SHOWN TO REMAIN SHALL BE RESTORED TO NEW WORK CONDITION AT NO ADDITIONAL COST TO THE OWNER.
- 18. WINDOWS AND DOORS SCHEDULED FOR REMOVAL SHALL BE REMOVED COMPLETELY. FASTENERS MAY BE CUT FLUSH WITH HEAD, JAMBS, AND SILLS IF THE NEW UNIT WILL CONCEAL FASTENER. PROTECT EXISTING SILLS SCHEDULED TO REMAIN. ALL EXISTING OPENINGS MUST BE FIELD MEASURED PRIOR TO SUBMITTAL OF SHOP DRAWINGS.
- 19. WHERE FINISHES ARE INDICATED TO BE REMOVED, REMOVAL SHALL INCLUDE ANY GROUT, ADHESIVES, FASTENERS, AND ALL OTHER ITEMS USED TO ATTACH THE FINISHES TO THE SURFACES THAT THEY COVER. 20. ANY FLOOR FINISHES DAMAGED BY THE DEMOLITION CONTRACTOR SHALL BE PATCHED TO MATCH EXISTING. 21. WHERE CEILINGS ARE TO BE REMOVED. ALL CEILINGS SYSTEMS INCLUDING GRID. TRIM HANGER, CLIPS, ETC, SHALL BE REMOVED DOUBLE CEILINGS ARE NOT PERMITTED UNLESS OTHERWISE NOTED.
- 22. REMOVE ALL CURTAINS AND BLINDS IN AREAS OF RENOVATION OR DEMOLITION, UNLESS NOTED OTHERWISE. 23. REMOVE MECHANICAL, ELECTRICAL AND PLUMBING ITEMS AS NOTED ON MECHANICAL, ELECTRICAL AND PLUMBING PLANS. COORDINATE WITH CIVIL, STRUCTURAL, MECHANICAL, ELECTRICAL, AND PLUMBING, FOR ADDITIONAL DEMOLITION NOTES. REMOVAL WORK IS INTENDED TO INCLUDE ALL ASSOCIATED ITEMS SUCH AS ELECTRICAL OUTLETS, SWITCHES, CONDUITS, CONTROLS, PIPING, MOUNTING BLOCKS, ETC., AS NOTED. THE CONTRACTOR SHALL REFER TO ALL CIVIL, STRUCTURAL, MECHANICAL, ELECTRICAL AND PLUMBING DRAWINGS AND SPECIFICATIONS FOR PROCEDURES CONCERNING RELATED TRADES IN AREAS WHICH REQUIRE DEMOLITION. REPAIR AND PATCH ANY AREAS DAMAGED DURING REMOVAL WORK.




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KEYNOTES DEMOLITION

D01 DEMOLISH FLOOR FINISH, PROTECT UNDERLYING WOOD FLOORING FOR REFINISHING

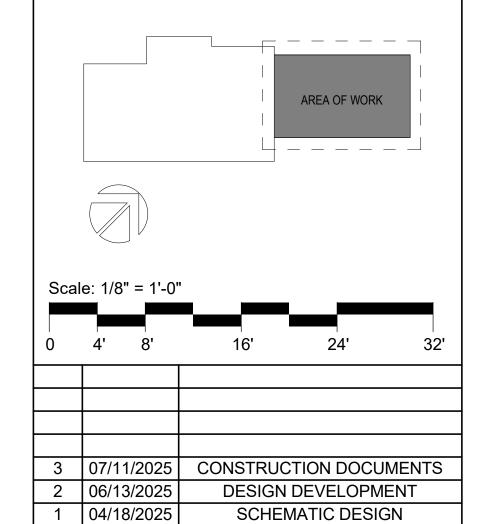- D02 DEMOLISH EXISTING PLUBMING FIXTURES
- D03 DEMOLISH EXISTING STOVE, HOOD, CAP VENT
- D04 REMOVE EXISTING DOOR; EXISTING FRAME TO REMAIN D05 DEMOLISH MILLWORK
- D08 DEMOLISH EXISTING FCU; SEE MECHANICAL DEMOLITION DRAWINGS



RUST MANOR INTERIOR RENOVATIONS

DESCRIPTION

802 CHILDRENS CENTER RD LEESBURG, VA 20175

DRAWING TITLE:


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FIRST FLOOR DEMOLITION PLAN
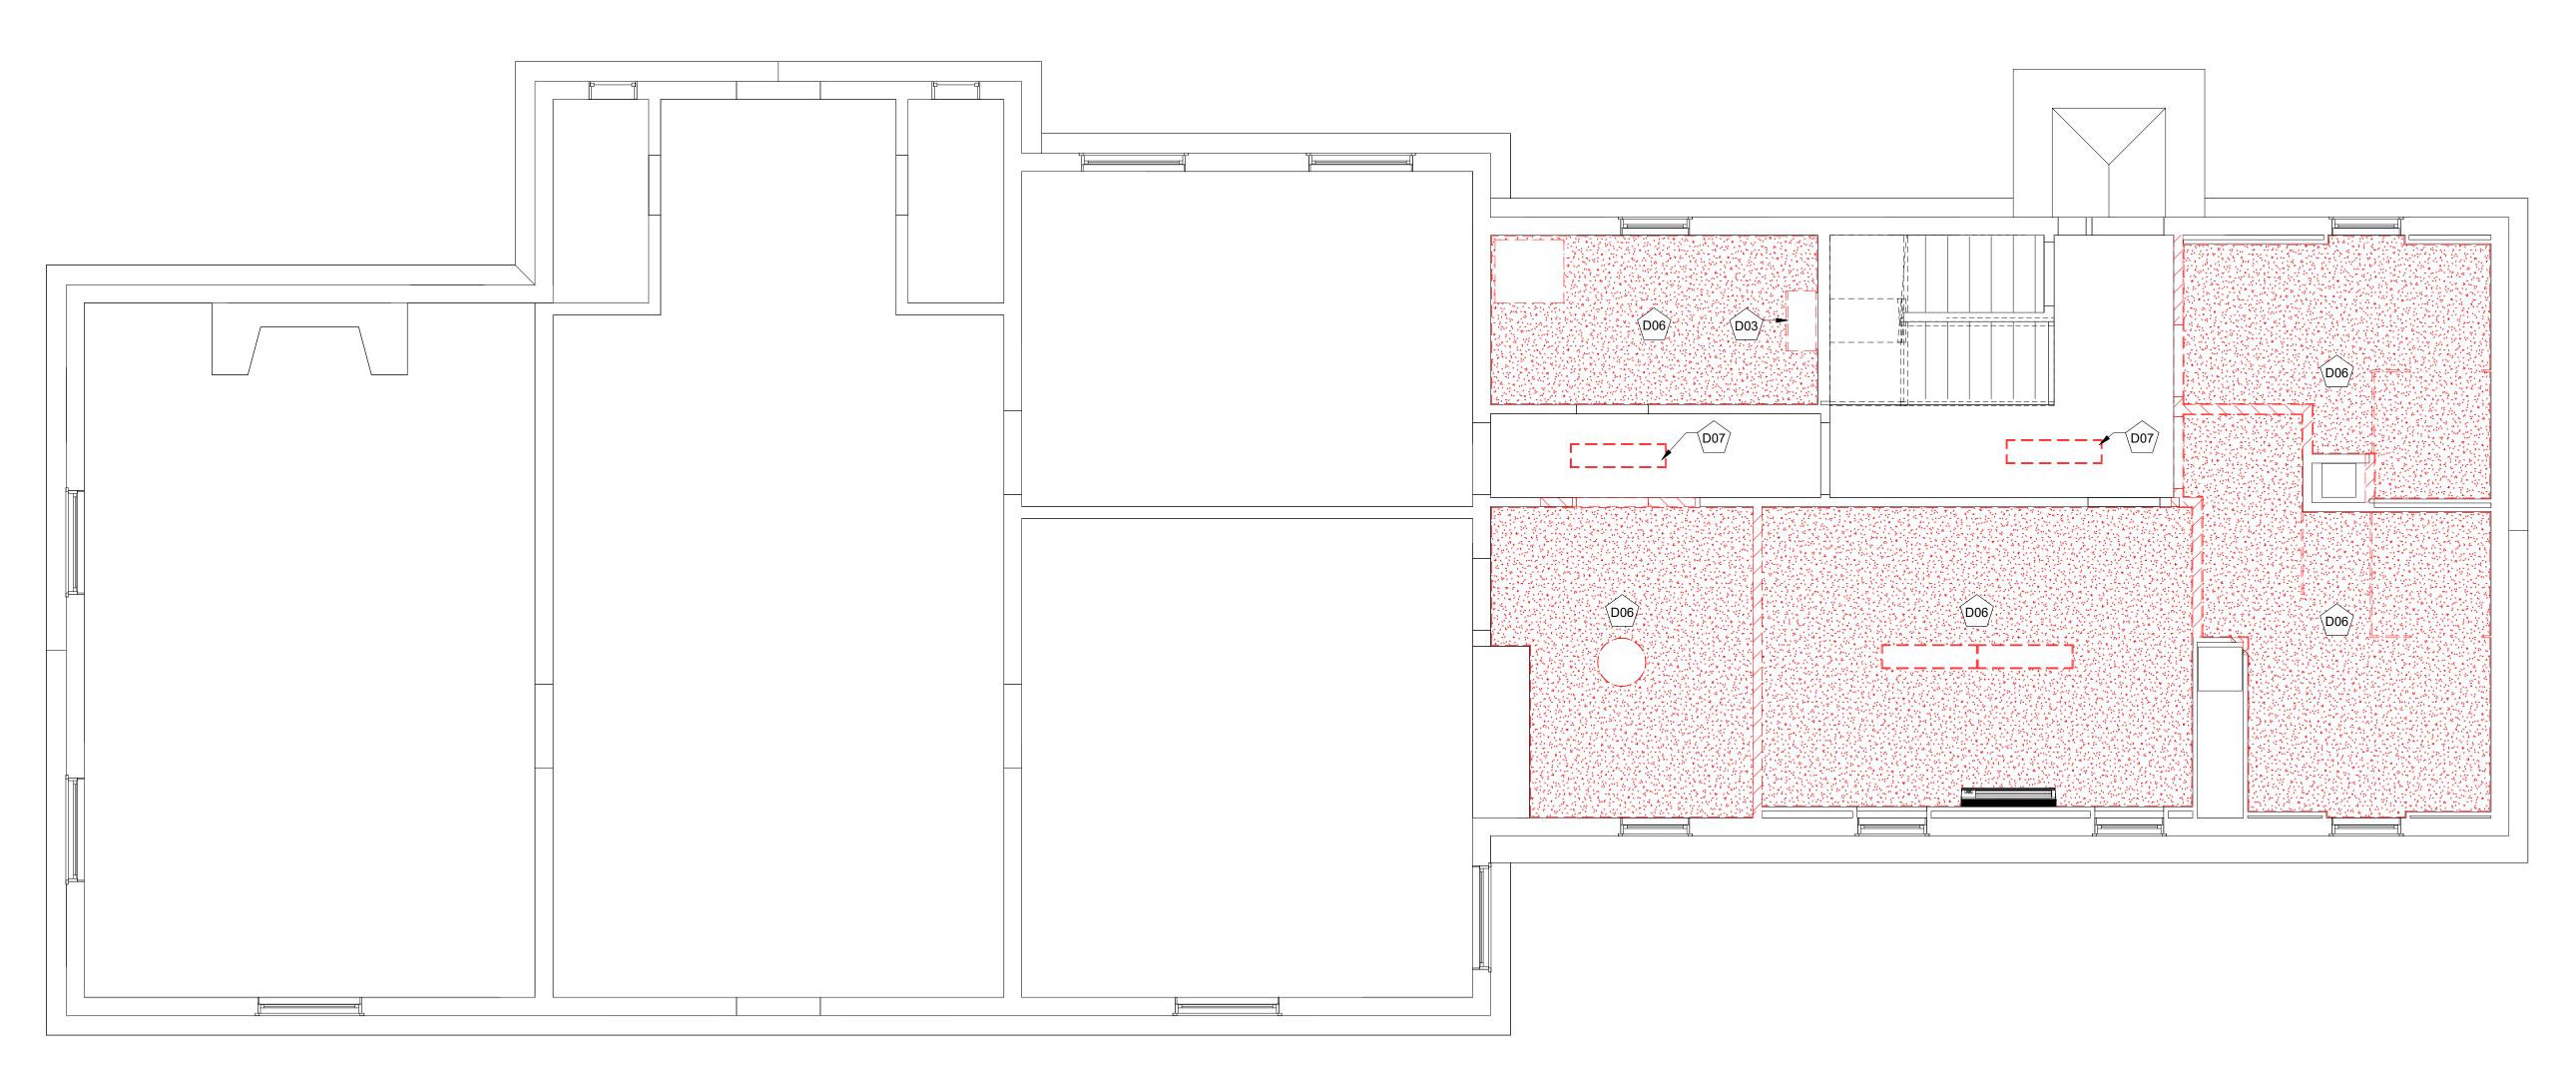
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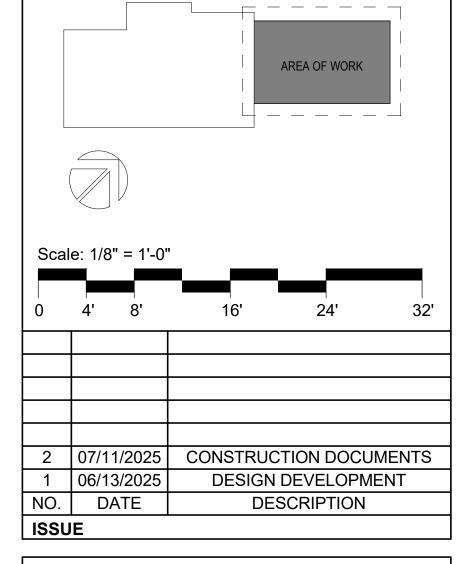
1 FIRST FLOOR DEMOLITION RCP SCALE: 1/4" = 1'-0"



KEYNOTES DEMOLITION RCP

D03 DEMOLISH EXISTING STOVE, HOOD, CAP VENT D06 DEMOLISH EXISTING CEILING AND ATTACHED LIGHTING FIXTURES

D07 DEMOLISH EXISTING LIGHTING FIXURE, PATCH AND REPAIR CEILING



RUST MANOR INTERIOR RENOVATIONS

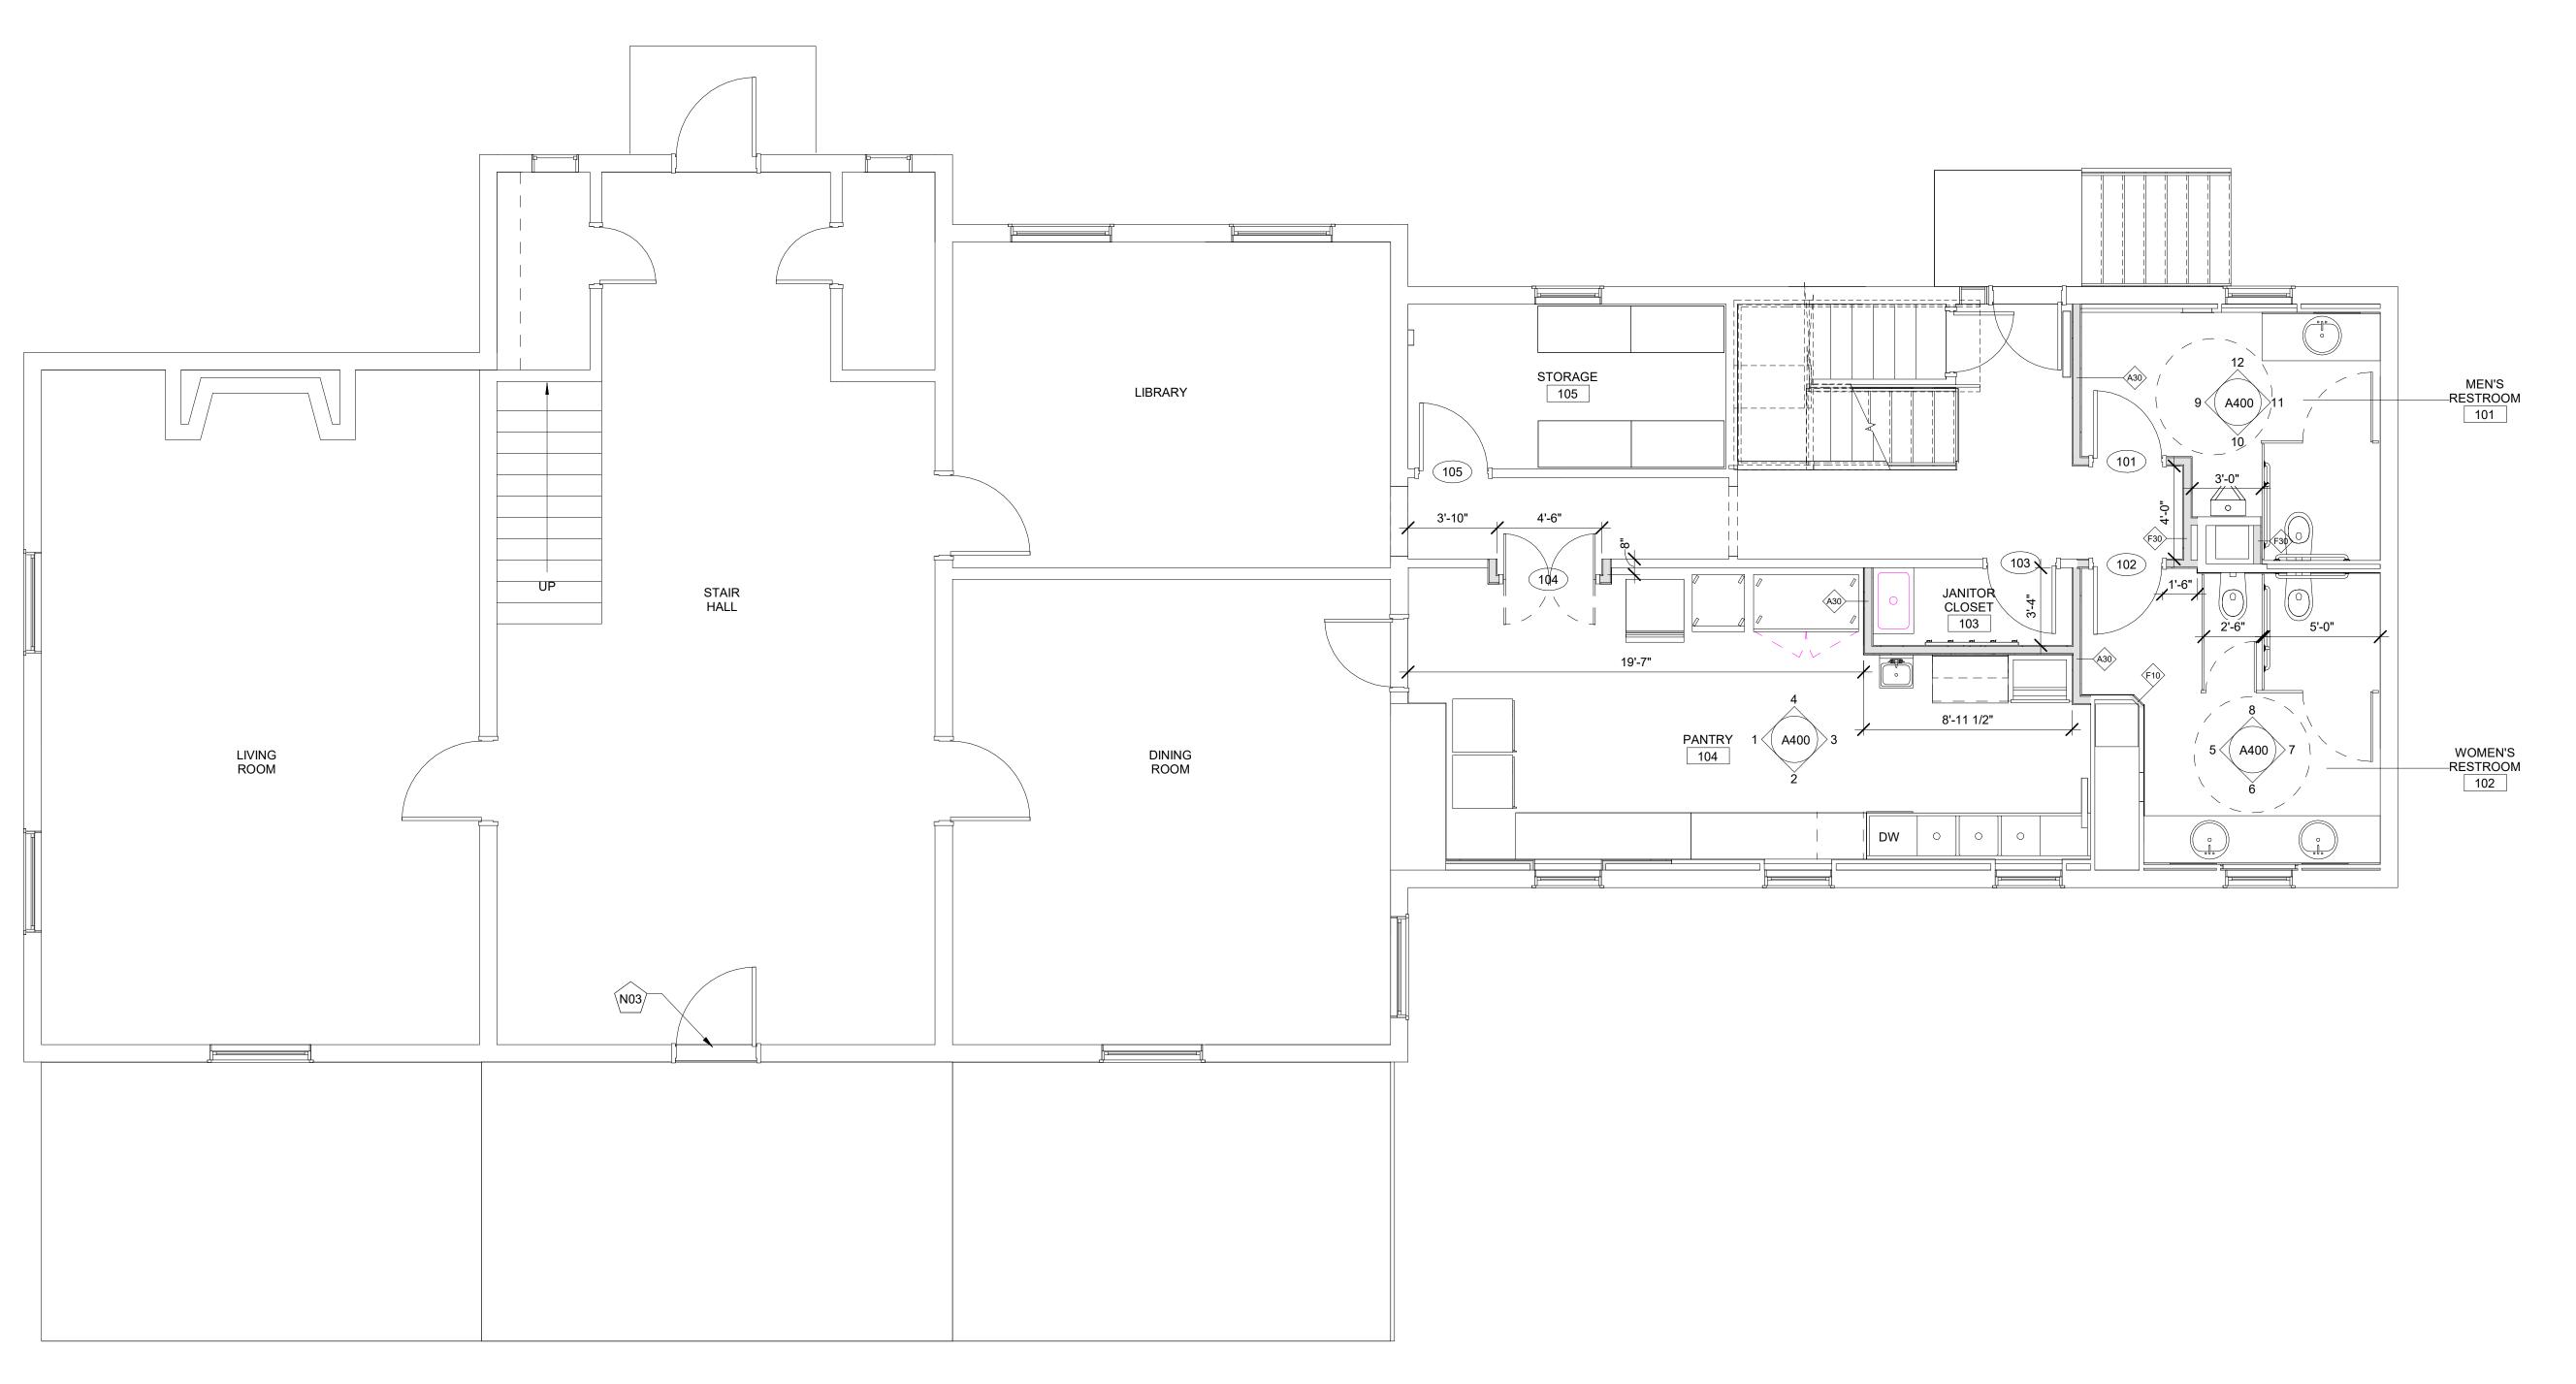
802 CHILDRENS CENTER RD LEESBURG, VA 20175

DRAWING TITLE: FIRST FLOOR DEMOLITION RCP

SCALE: As indicated

DATE: 10/05/09

DRAWING NUMBER: COMM. NO: DRAWN: D101 CHECKED:



OVERALL FIRST FLOOR PLAN
SCALE: 1/4" = 1'-0"

GENERAL PLAN NOTES

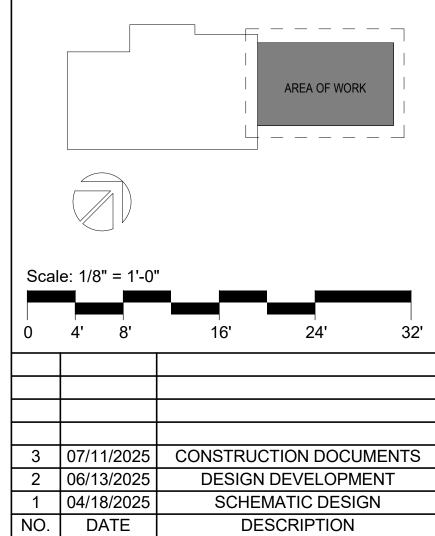
GENERAL NOTE APPLICABLE TO ALL DRAWINGS - ITEMS AND CONDITIONS DETAILED, NOTED OR OTHERWISE IDENTIFIED ON ONE OF THE SECTIONS OR DETAILS ARE APPLICABLE AND BINDING TO ALL OTHER SECTIONS AND DETAILS FOR IDENTICAL OR SIMILAR CONDITIONS.

- 1. UNLESS NOTED OTHERWISE, ALL AREAS OUTSIDE OF DESIGNATED AREA OF WORK ETR. CUT, PATCH AND RESTORE FINISHES FOR MINOR WORK OUTSIDE THE AREA OF WORK. COORDINATE WITH OTHER DISCIPLINES.
- 2. REFER TO SCHEDULE FOR PARTITION TYPES.
- 3. UNLESS NOTED OTHERWISE, WALLS SHALL EXTEND TO THE FLOOR OR ROOF DECK ABOVE AND SEALED PER PARTITION TYPE. REFER TO THE CODE COMPLIANCE PLANS FOR IDENTIFICATION OF ALL SMOKE AND FIRE WALL CONDITIONS. PERIMETER CORRIDOR AND LOBBY WALLS SHALL BE BUILT TO RESIST THE PASSAGE OF SMOKE
- 4. REFER TO WALL SECTIONS AND DETAILS FOR EXTERIOR WALL TYPES AND CONSTRUCTION.
- 5. DIMENSIONS ON PLANS ARE FROM FACE OF MASONRY TO FACE OF MASONRY, FACE OF MASONRY TO FACE OF GYPSUM BOARD OR FACE OF GYPSUM BOARD TO FACE OF GYPSUM BOARD.
- 6. COLUMN GRID LINE, WHERE SHOWN, ARE FOR REFERENCE ONLY, REFER TO STRUCTURAL DRAWINGS FOR COLUMN LOCATIONS.
- 7. REFER TO FURNISHING AND/OR ENLARGED PLANS FOR CASEWORK, MILLWORK, DISPLAY BOARDS, SHELVING UNITS, TV MOUNTING BRACKETS, LOCKERS, FURNITURE, ETC.
- 8. UNLESS INDICATED OTHERWISE, THE SAME WALL TYPE NEXT TO A DOOR OR OPENING SHALL CONTINUE OVER THE DOOR OR OPENING.
- 9. PLAN LOCATION OF DOORS AND FRAMES RELATIVE TO THE PLANE OF THE WALL IS DIAGRAMMATIC ONLY. REFER TO THE REFERENCED JAMB AND HEAD CONDITION DETAILS TO DETERMINE ACTUAL PLACEMENT OF DOOR AND FRAME.



KEYNOTES

N03 REPAIR EXISTING DOOR SILL, REPLACE WOOD WITH MATCHING



RUST MANOR INTERIOR RENOVATIONS

802 CHILDRENS CENTER RD LEESBURG, VA 20175

DRAWING TITLE:

10/05/09


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OVERALL FIRST FLOOR PLAN

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EQUIPMENT SCHEDULE								
MARK	DESCRIPTION	MANUFACTURER	MODEL	QUANTITY	COMMENTS			
J01	MOP SINK	ADVANCE TABCO	9-OP-20	1				
J02	MOP-BROOM HOLD	BRADLEY CORPORATION	9955	1				
K01	REACH-IN SOLID SWING DOOR REFRIGERATOR WITH HYDROCARBON REFRIGERANT	TRUE FOOD SERVICE EQUIPMENT, INC.	T-49-HC	1				
K02	REACH-IN SOLID SWING DOOR FREEZER WITH HYDROCARBON REFRIGERANT	TRUE FOOD SERVICE EQUIPMENT, INC.	T-23F-HC	1				
K03	ICE MAKER	MANITOWOC ICE	IT0750N	1				
K04	ICE STORAGE BIN	MANITOWOC ICE	D-400	1				
K06	HAND SINK	ADVANCE TABCO	7-PS-20	1				
K07	SANITIZING DISHWASHER	GENERAL ELECTRIC	GPT225SSLSS	1				
K08	THREE COMPARTMENT SINK	EAGLE GROUP	FN2060-3-24-14/3	1				
K09	PREP TABLE	ADVANCE TABCO	TKSS-246	1				
K10	BUILT-IN COMBINATION CONVETION MICROWAVE/CONVECTION WALL OVEN	GENERAL ELECTRIC	PT7800SHSS	1				
K11	WALL-MOUNTED OSCILLATING FAN	AIR KING	99539	1				
S01	STORAGE RACK	METRO		3	RELOCATE EXIST			
S02	LOCKING STORAGE CAGE FOR ALCOHOL			1	RELOCATE EXIST			
S03	TIME CLOCK	KRONOS		1	RELOCATE EXIST			





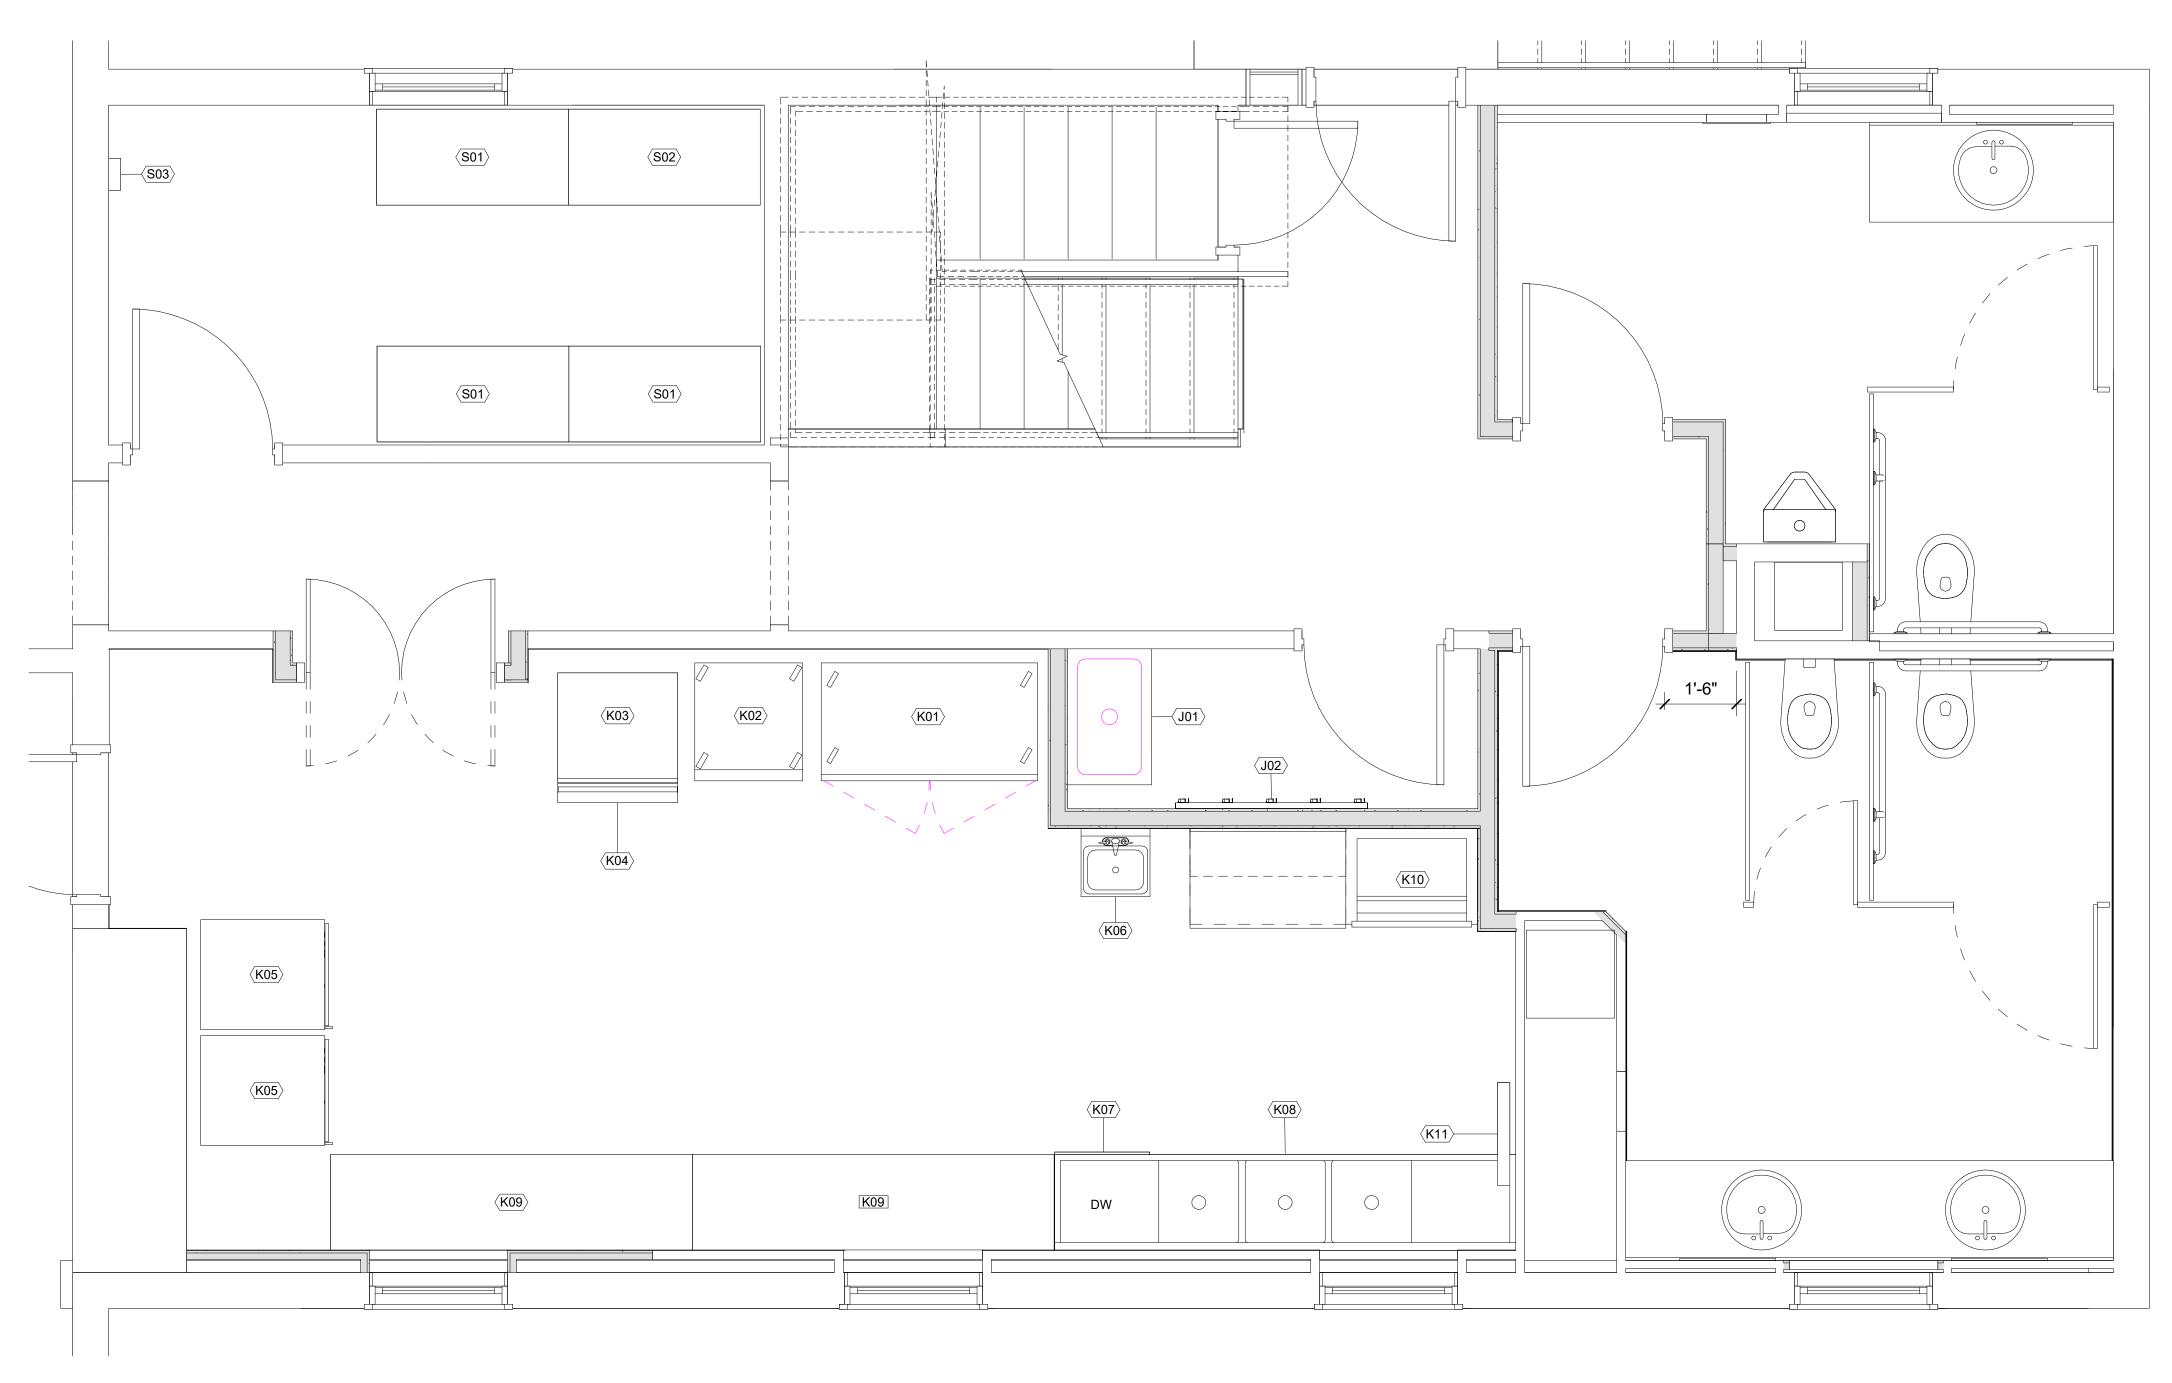

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INTERIOR RENOVATIONS

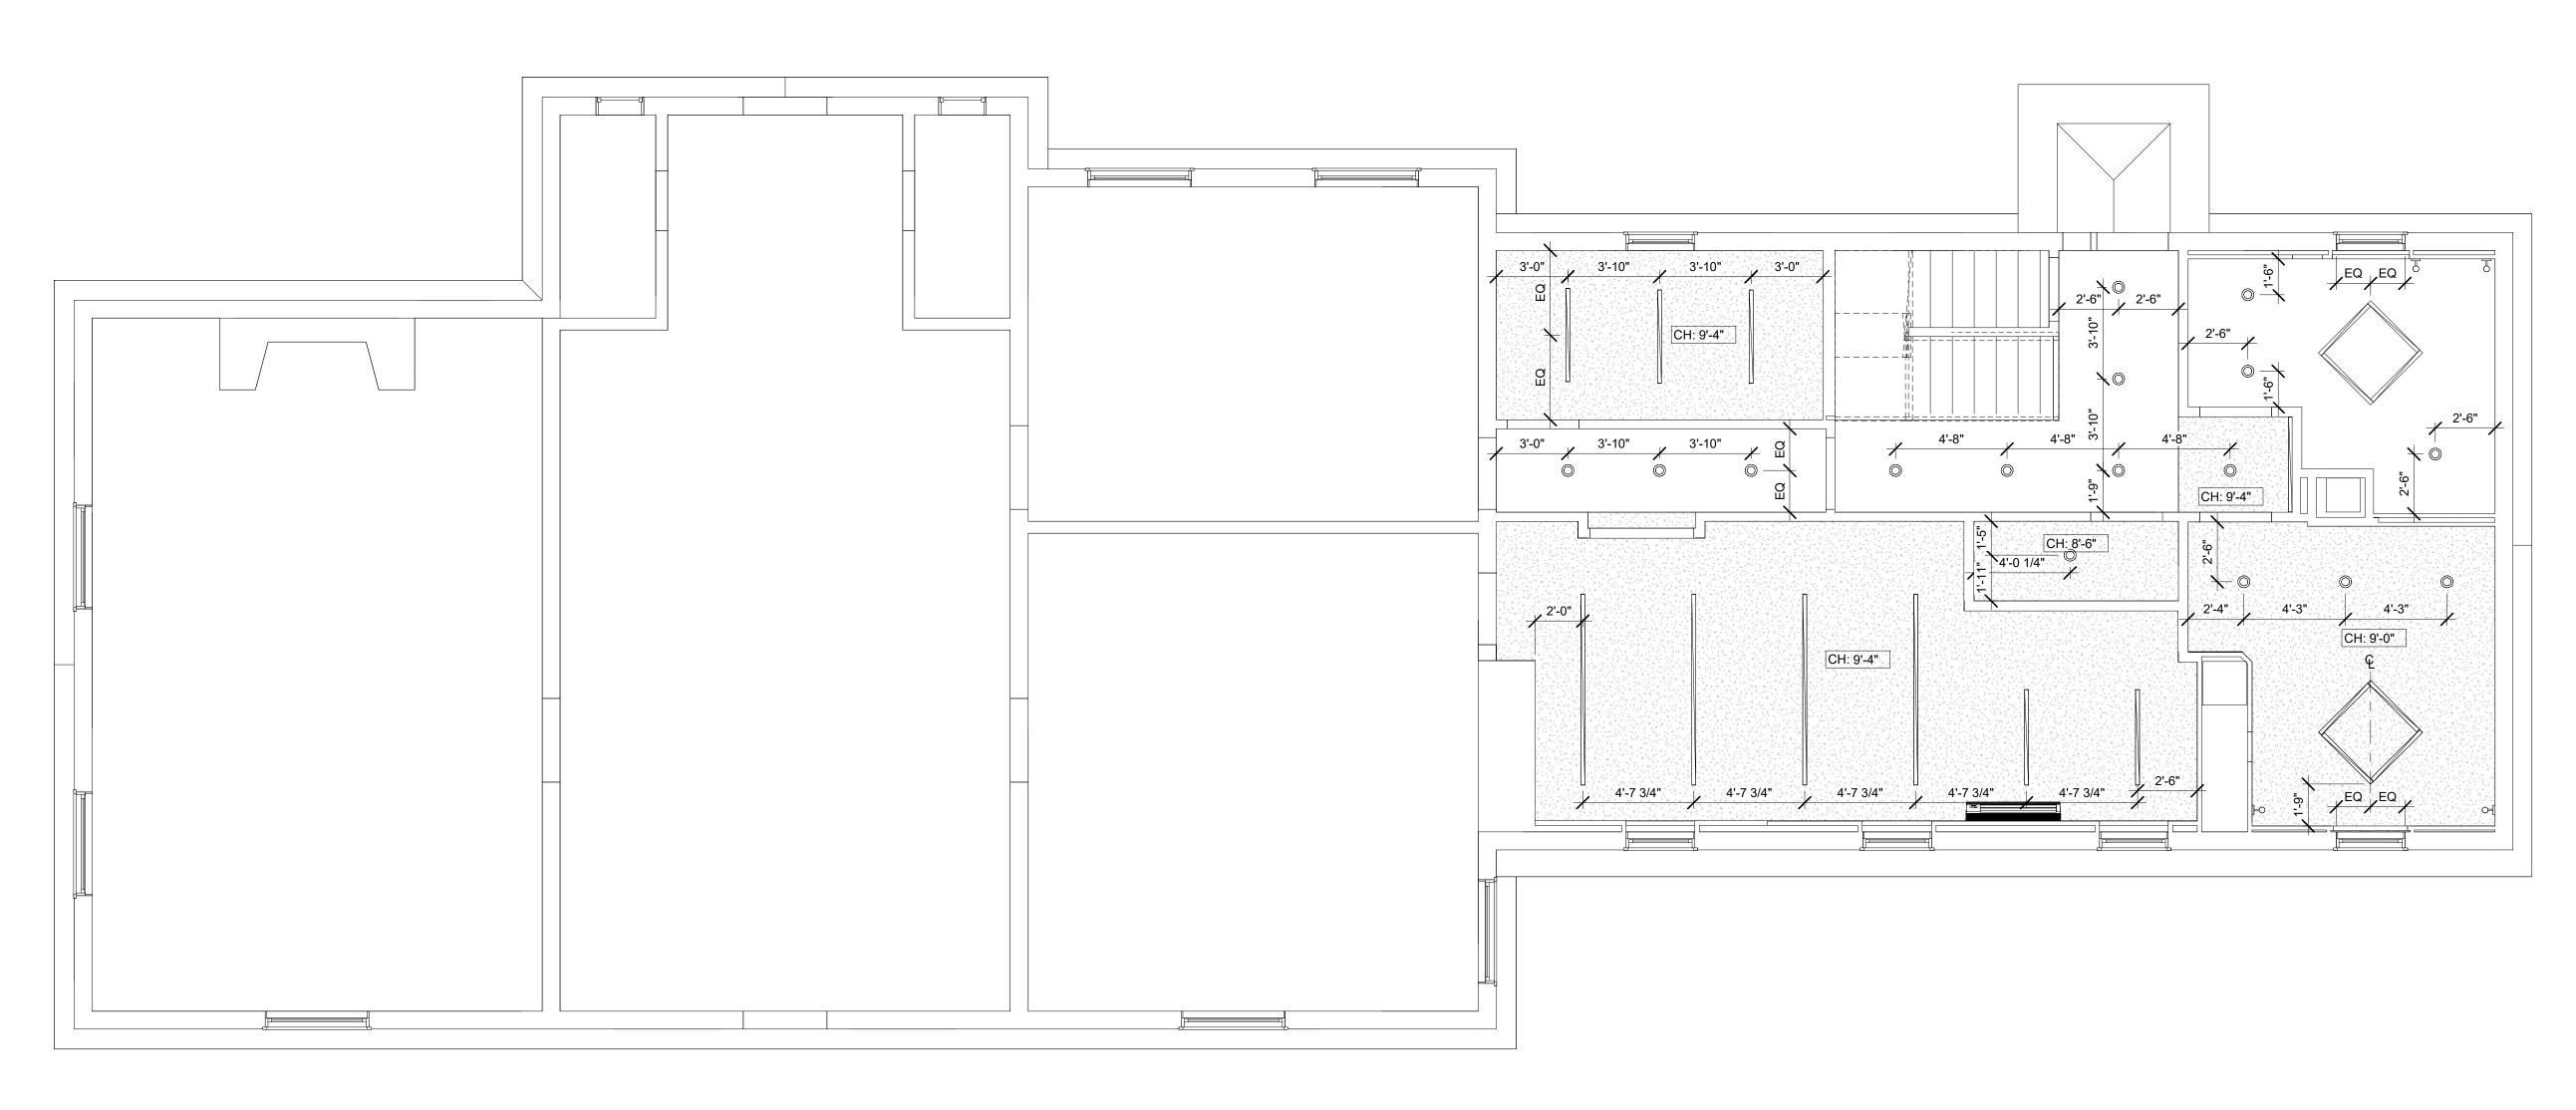
802 CHILDRENS CENTER RD LEESBURG, VA 20175

DRAWING TITLE: **EQUIPMENT PLAN**

COMM. NO: 230210 DRAWING NUMBER: DRAWN: A101 CHECKED:

SCALE: 1/2" = 1'-0"

DATE: 10/05/09



1 FIRST FLOOR RCP SCALE: 1/4" = 1'-0"



GENERAL NOTE APPLICABLE TO ALL DRAWINGS - ITEMS AND CONDITIONS DETAILED NOTED OR OTHERWISE IDENTIFIED ON ONE OF THE SECTIONS OR DETAILS ARE APPLICABLE AND BINDING TO ALL OTHER SECTIONS AND DETAILS FOR IDENTICAL OR SIMILAR CONDITIONS.

- 1. TYPICAL CEILING HEIGHT SHALL BE 9'-0" UNLESS OTHERWISE INDICATED ON REFLECTED CEILING PLANS. TOILETS AND STORAGE ROOMS TO BE 8'-0".
- 2. REFER TO ELECTRICAL DRAWINGS FOR LIGHT PATTERN AND EXIT LIGHT LOCATIONS. NOTIFY ARCHITECT OF DISCREPANCIES PRIOR TO SHOP
- 3. ALL WALLS SHOWN EXTEND TO THE STRUCTURAL DECK (SEE WALL TYPES). AT CORRIDOR CHASE WALLS AND LOCKER FIN WALLS, EXTENDED 4" ABOVÉ THE CEILING.
- 4. REFER TO MECHANICAL, ELECTRICAL, AND PLUMBING DRAWINGS FOR ITEMS NOT SHOWN ON CEILING PLAN. GRILLES, SPEAKERS, SPRINKLERS, HEAT & SMOKE DETECTORS, SHALL BE CENTERED IN TILES UNLESS NOTED OTHERWISE.
- 5. ALL BULKHEAD DIMENSIONS ARE FROM FINISH FACE OF WALL OR BULKHEAD TO FINISH FACE OF BULKHEAD.
- 6. PROVIDE 1/2" REVEALS BETWEEN DISSIMILAR MATERIALS ON THE SAME PLANE AT THE CEILINGS.
- 7. IN AREAS OF EXPOSED CEILINGS, PAINT EXPOSED STRUCTURE, UNDERSIDE OF DECK, SPRINKLER PIPING, CONDUIT AND ALL MISCELLANEOUS OVERHEAD ITEMS, COLORS TO BE SELECTED BY ARCHITECT.



2	07/11/2025	CONSTRUCTION DOCUMENTS
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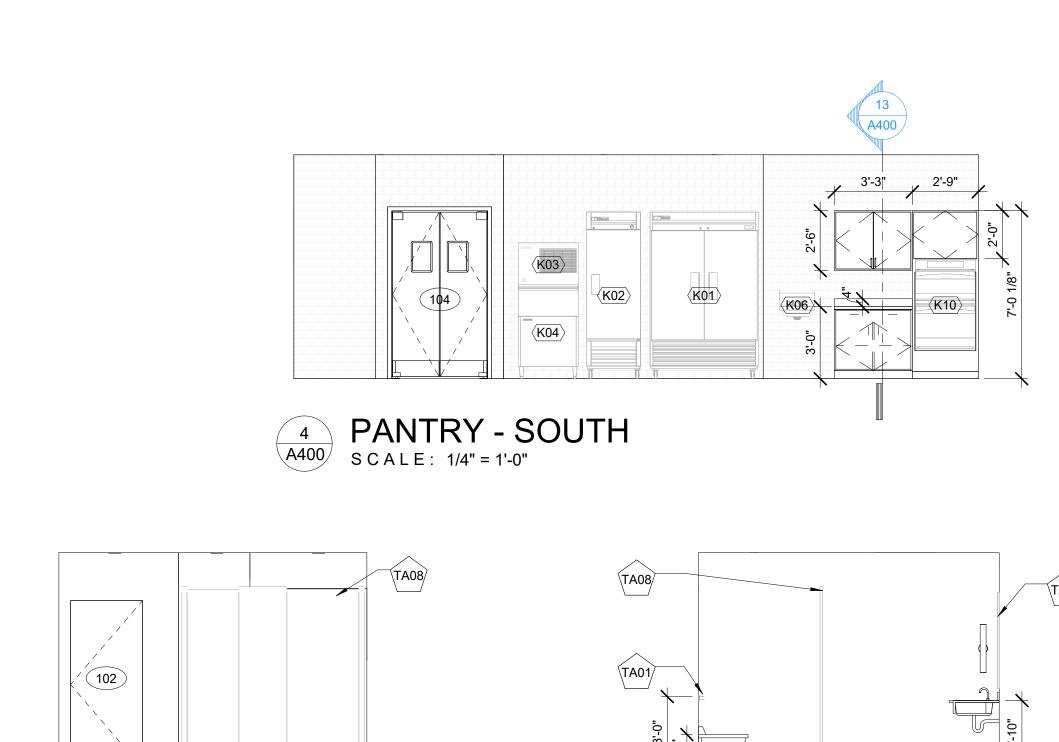
RUST MANOR INTERIOR RENOVATIONS

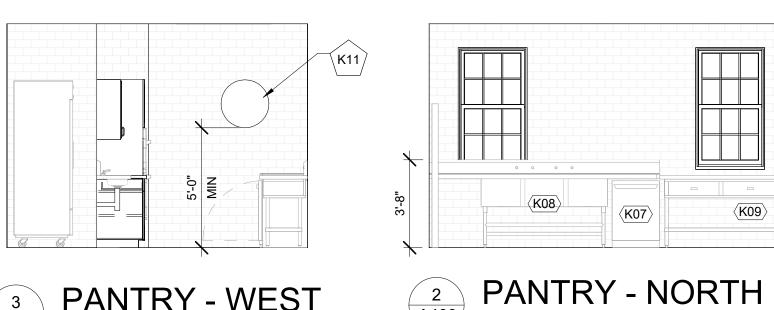
802 CHILDRENS CENTER RD LEESBURG, VA 20175

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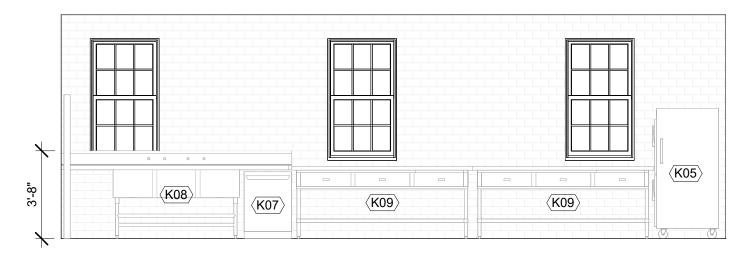
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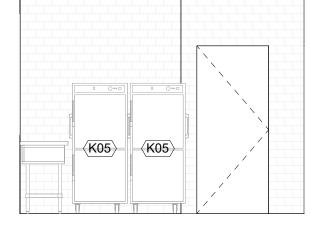




PANTRY - WEST SCALE: 1/4" = 1'-0"

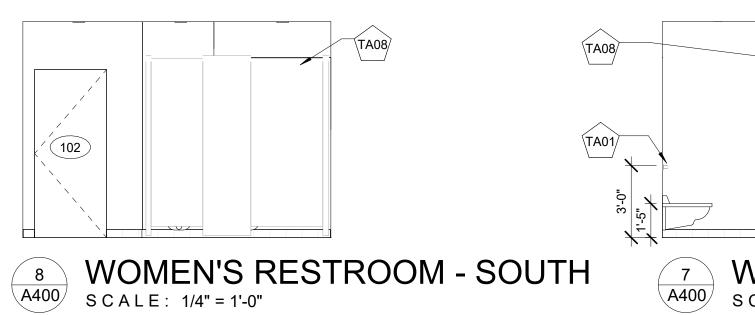


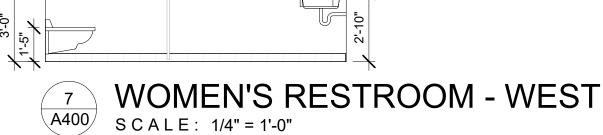


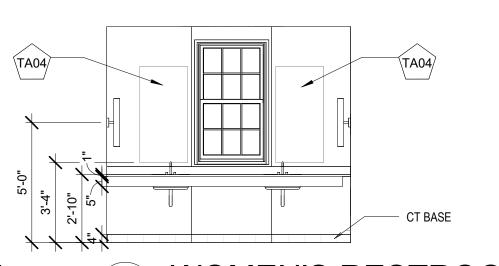

















A400 S C A L E: 1/4" = 1'-0"

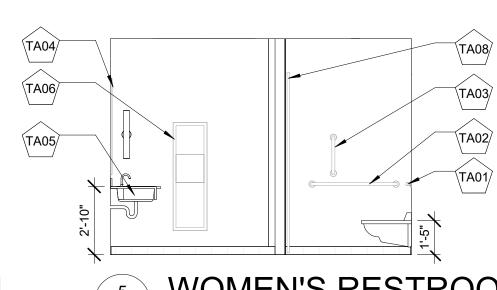




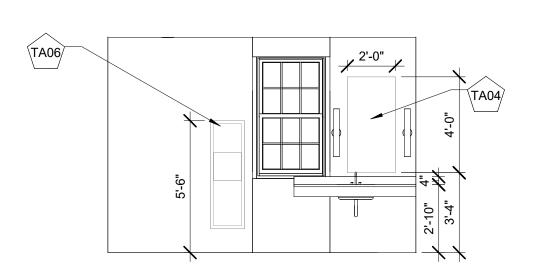




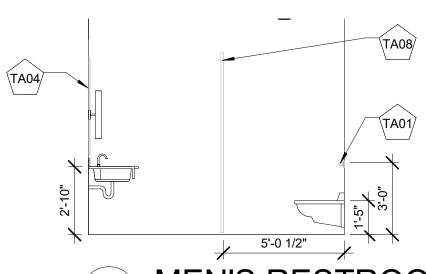

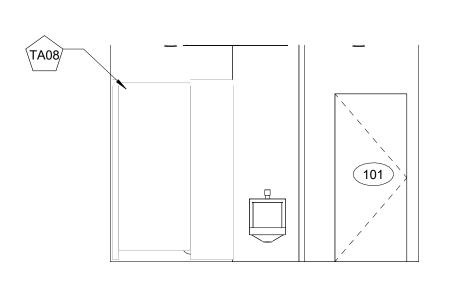
MEN'S RESTROOM - WEST A400 S C A L E: 1/4" = 1'-0"



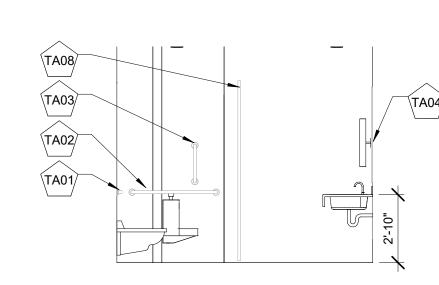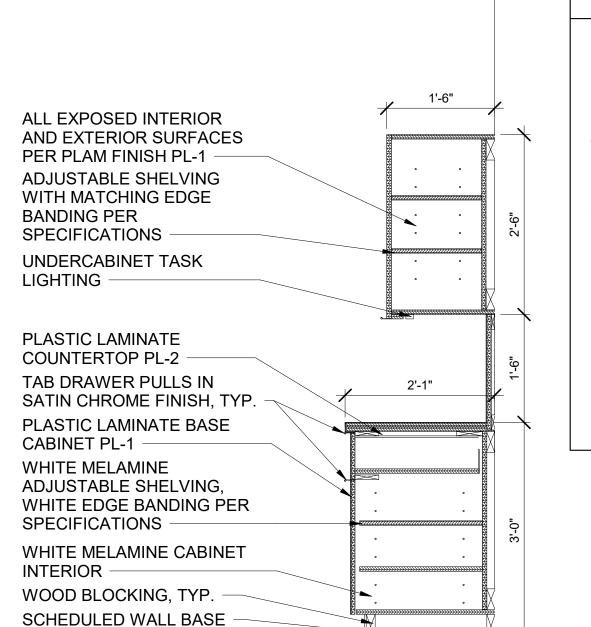MEN'S RESTROOM - NORTH SCALE: 1/4" = 1'-0"







TYPICAL TOILET ROOM NOTES

- 1. AT ALL FLOOR DRAINS IN AREAS OF NEW CONCRETE SLABS, PROVIDE 18" X 18" SLOPED SUMP TO DRAIN.
- 2. ALL ACCESSORIES ARE SURFACE MOUNTED UNLESS NOTED OTHERWISE.
- 3. PROVIDE 1 PAPER TOWEL DISPENSER AND SOAP DISPENSER (ITEMS 1 & 2) AT EACH SINK LOCATION THROUGHOUT THE BUILDING. NO SUBSTITUTIONS WILL BE PERMITTED FOR TOILET ACCESSORIES UNLESS WRITTEN APPROVAL IS OBTAINED FROM THE OWNER'S
- MAINTENANCE DEPARTMENT. 5. PROVIDE UTILITY SHELF W/ MOP (ITEM 8) HOLDER IN ALL JANITOR'S
- 6. LOCATE SANITARY NAPKIN DISPOSAL UNITS 2'-0" O.C. FROM ADJACENT WALL AND 2'-0" A.F.F. TO THE TOP OF THE UNIT. LOCATE AT ALL WOMEN'S
- TOILET. ALL WALLS, BASE OF ALL TOILET ROOMS TO BE CERAMIC TILE.
- PATTERNS/COLORS TBS.
- 8. ALL HANDRAIL MOUNTING SHALL COMPLY W/ ADA REQUIREMENTS. 9. CENTERLINES OF ALL TOILETS IN STALLS SHALL BE EQUAL DISTANT BETWEEN PARTITIONS UNLESS DIMENSIONED OR NOTED OTHERWISE.
- 10. WHERE TOILET ACCESSORIES FALL PARTIALLY ON THE CERAMIC TILE EITHER OMIT THE TILE UNDER THE ACCESSORY FOR A FLUSH FIT OR PROVIDE CONTINUOUS WOOD BLOCKING.
- 11. REFER TO PLUMBING PLANS FOR FLOOR DRAIN LOCATIONS AND SUMPS -FLOOR DRAINS IN EACH BUILDING SERVICES CLOSET, SHOWER, AND TOILET ROOMS.
- 12. REFER TO PLUMBING PLANS AND SCHEDULE FOR TOILET FIXTURE TYPE LOCATIONS.



CONSTRUCTION DOCUMENTS

DESIGN DEVELOPMENT

DESCRIPTION

2 07/11/2025

1 | 06/13/2025

DATE

DRAWING TITLE:

SCALE: As indicated DATE: 10/05/09

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KEYNOTES ELEVATIONS

TA06 PAPER TOWEL DISPENSER AND TRASH RECEPTICAL

TA08 FLOOR MOUNTED TOILET PARTITION WITH OVERHEAD

K11 WALL-MOUNTED OSCILLATING FAN

TA01 36" GRAB BAR

TA02 42" GRAB BAR TA03 18" GRAB BAR

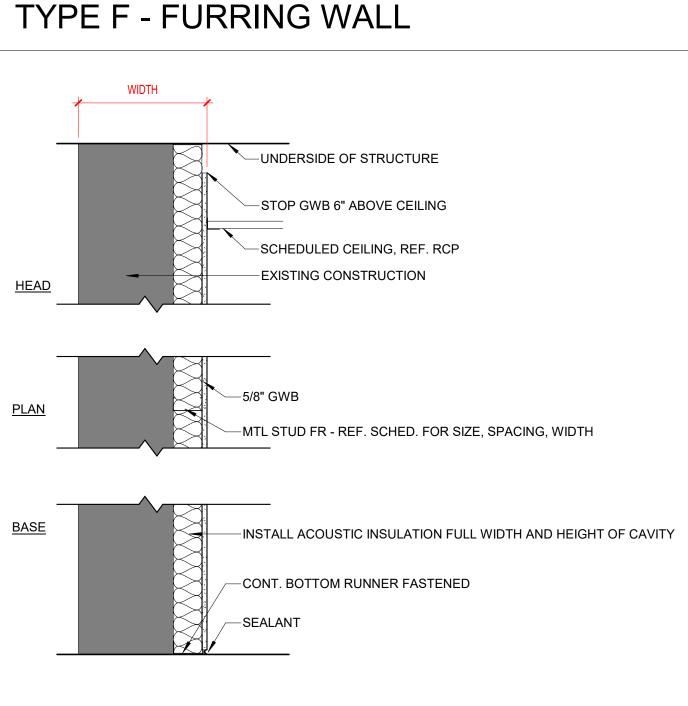
TA04 24"X48" MIRROR

TA05 UNDERMOUNT LAVATORY

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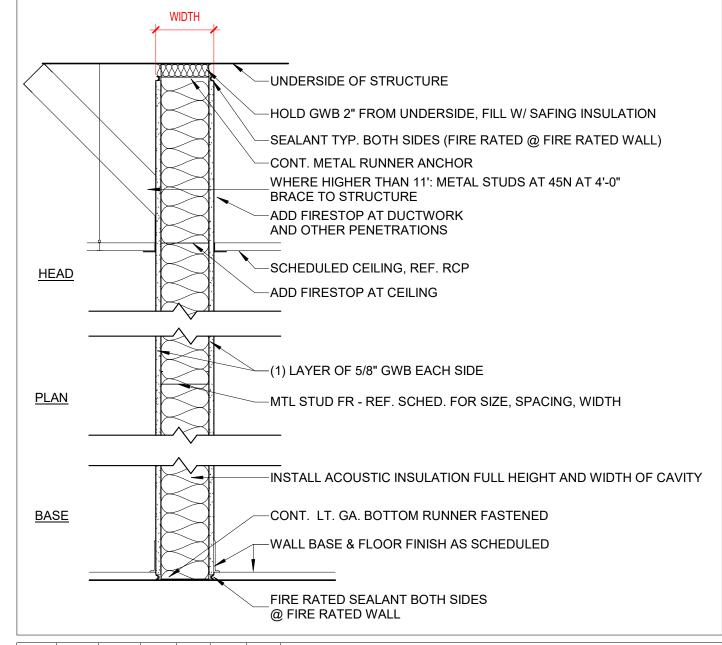
INTERIOR ELEVATIONS

PANTRY MILLWORK SECTION A400 S C A L E: 3/4" = 1'-0"



PARTITION TYPE	ASSEMBLY WIDTH	STUD WIDTH	STC RATING	UL CODE	SOUND INSULATION	FIRE RATING	COMMENTS
F10	2 1/4"	1 5/8"			YES	0 HR	
F30	4 1/4"	3 5/8"			YES	0 HR	

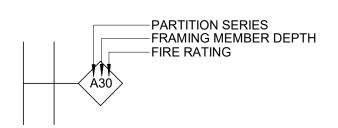
TYPE A - FULL HEIGHT GWB PARTITION



A 1/8" 3 5/8" 45 A 1/8" 3 5/8" 45

PARTITION LEGEND

PARTITION TYPE SYMBOL



GENERAL NOTES

GENERAL NOTE APPLICABLE TO ALL DRAWINGS. NOTES, DETAILS, AND CONDITIONS SHOWN ARE APPLICABLE TO ALL OTHER SECTIONS AND DETAILS FOR IDENTICAL OR SIMILAR CONDITIONS.

1. NOT ALL WALL TYPES ARE REPRESENTED IN THIS PROJECT. WALL TYPES

- SHOWN ARE GENERAL IN NATURE AND DO NOT COVER EVERY VARIATION THAT MAY OCCUR THROUGHOUT THE PROJECT. REFER TO WALL SECTIONS AND DETAILS FOR ADDITIONAL INFORMATION.

 2. TYPICAL GYPSUM BOARD/STUD WALL PARTITION SHALL BE TYPE 2, 3-5/8"
- 2. TYPICAL GYPSUM BOARD/STUD WALL PARTITION SHALL BE TYPE 2, 3-5/8"
 METAL STUDS AT 16" 0.C. WITH 5/8" ABUSE-RESISTANT GYPSUM BOARD
 UNLESS INDICATED OTHERWISE BY WALL TYPE SYMBOLS, WALL SECTIONS,
 OR OTHER DETAILS.
- FURRING CHANNELS AND STUDS SHALL BE 16" O.C. MAXIMUM UNLESS SPECIFICALLY NOTED OTHERWISE.
 TYPICAL CMU INTERIOR PARTITION SHALL BE TYPE 5 UNLESS INDICATED
- OTHERWISE BY WALL TYPE SYMBOLS, SECTIONS OR OTHER DETAILS.

 5. WALLS SHALL EXTEND FULL HEIGHT FROM FLOOR SLAB TO THE FLOOR OR ROOF DECK ABOVE UNLESS SPECIFICALLY NOTED OTHERWISE. IN CORRIDORS, EXTEND COLUMN CHASE AND LOCKER FIN WALLS 6" ABOVE CEILING ONLY.
- SEE WALL SECTIONS AND DETAILS FOR EXTERIOR WALL TYPES.
 WALL TYPES DETAILS DO NOT SHOW LATERAL BRACING OR WALL REINFORCING. REFER TO STRUCTURAL AND OTHER DRAWINGS FOR THAT INFORMATION.
- 8. THE GAUGE OF ALL METAL STUDS SHALL BE SIZED TO LIMIT WALL DEFLECTION TO WITHIN 1/240 PER ASTM C645 UNLESS A HEAVIER GAGE IS INDICATED ON THE WALL TYPE OR DETAILS.
- 9. PROVIDE SPACE FOR DEFLECTION OF BEAMS, JOISTS, AND STEEL DECK AT TOP OF ALL WALLS THAT RUN TO THE DECK. FILL GAP WITH NON COMBUSTIBLE, COMPRESSIBLE FILLER ON NON RATED WALLS AND APPROVED FIRE SAFING ON RATED WALLS REFER TO TYPICAL DETAILS THIS SHEET.
- 10. IN ROOMS WHERE NO FINISHED CEILING IS PROVIDED, EXTEND ALL CHASE WALLS TO FLOOR OR ROOF DECK ABOVE.
- 11. COORDINATE WITH FINISH SCHEDULE FOR FINISH TYPE AND COLOR TO BE APPLIED.

FIRE RATED WALLS

- 12. REFER TO THE CODE STUDY AND FLOOR PLANS FOR IDENTIFICATION OF ALL SMOKE AND FIRE WALL CONDITIONS / LOCATIONS. IN ADDITION TO THE REQUIREMENTS INDICATED ON THE CODE STUDY AND FLOOR PLANS, ALL CORRIDOR AND VESTIBULE WALLS SHALL BE BUILT TO RESIST THE PASSAGE OF SMOKE.
- 13. FIRE WALLS, FIRE SEPARATION WALLS, SMOKE BARRIER WALLS AND WALLS REQUIRED TO RESIST THE PASSAGE OF SMOKE SHALL EXTEND FULL HEIGHT FROM FLOOR SLAB TO THE UNDERSIDE OF FLOOR OR ROOF DECK ABOVE. TOP OF WALL SHALL BE AND SHALL BE SEALED TIGHT TO THE DECK OR STRUCTURAL MEMBER WITH AN APPROVED FIRE RESISTIVE JOINT SYSTEM. SEAL ALL PENETRATIONS AND TOPS OF WALLS IN ACCORDANCE WITH SPECIFICATION DIVISION 7 SECTION - FIRE RESISTIVE JOINT SYSTEMS. WALLS AT FIRE AND SMOKE CONDITIONS AND LOCATIONS, LISTED ABOVE, SHALL BE BUILT TIGHT TO DUCTS, PIPES AND PENETRATIONS AND SHALL BE TERMINATED IN ACCORDANCE WITH WALL TERMINATION DETAILS ON THIS SHEET. FILL FLUTES IN FLOOR AND ROOF DECKS AS INDICATED. WHERE WALLS AT FIRE AND SMOKE CONDITIONS AND LOCATIONS, ARE INTERRUPTED BY STRUCTURAL MEMBERS, PROVIDE FIRE RESISTIVE JOINT SYSTEM IN AREAS BETWEEN TOP AND/OR SIDE OF WALL AND STRUCTURAL MEMBER AND BETWEEN DECK ABOVE AND STRUCTURAL MEMBER IN ACCORDANCE WITH APPROVED FIRE RESISTIVE JOINT SYSTEM PER TYPICAL WALL TERMINATION NOTE #4 BELOW.
- 14. ALL WALLS WITH FIRE RATING INDICATED SHALL BE BUILT IN STRICT CONFORMANCE WITH UL TESTED ASSEMBLY OR OTHER TESTED ASSEMBLY PROVIDING THE FIRE RATING INDICATED.

ACOUSTICAL ISOLATION/BLOCKING/SUPPORT

- 15. IN ALL WALLS WITH SOUND ATTENUATION BLANKETS OR AN STC RATING LISTED; OUTLETS, SWITCHES, ETC., SHALL NOT BE LOCATED BACK TO BACK. OUTLETS SHALL BE OFFSET AND SEALED. PERIMETERS OF WALLS (AT ADJACENT WALLS, COLUMNS, CEILINGS, ETC.) SHOULD BE SEALED. ADDITIONALLY, WALL PENETRATIONS SHALL BE SEALED WITH APPROPRIATE
- TYPE OF ACOUSTIC SEALANT.

 16. WHERE WALLS ARE INDICATED TO EXTEND FULL HEIGHT TO THE DECK BUT STOP AT A STRUCTURAL MEMBER, SEE THE TYPICAL DETAILS ON THIS SHEET FOR THE APPROPRIATE CLOSURE CONDITIONS. IF EXACT CONDITION IS NOT INDICATED, MODIFY CLOSEST CONDITION FOR SPECIFIC APPLICATION.
- 17. PROVIDE 4" HIGH X 18 GA. X LENGTH REQUIRED STEEL PLATE BLOCKING OR 2x FRT WD BLOCKING IN ALL STUD WALLS WHERE REQUIRED TO ATTACH LOCKERS, CASEWORK, SHELVING, LIGHTS, ELECTRICAL DEVICES, TOILET ACCESSORIES AND ANY OTHER ITEM WHICH REQUIRE SECURE ATTACHMENT TO THE WALLS.
- 18. PROVIDE CONTINUOUS SEALANT AT BASE OF ALL GYP. BD. WALLS (BOTH SIDES), TYPICAL.

ELECTRICAL BOXES IN FIRE RATED WALLS

ELECTRICAL BOXES IN FIRE RATED PARTITIONS SHALL NOT EXCEED 16
SQUARE INCHES IN AREA (IF 4"X4"), SHALL BE MADE OF STEEL, AND SHALL BE
SPACED SUCH THAT THE CUMULATIVE AREA OF BOX CUTOUTS IN THE
FIREWALL DOES NOT EXCEED 100 SQUARE INCHES PER 100 SQUARE FEET OF
WALL AREA. ELECTRICAL BOXES ON OPPOSITE SIDES OF THE SAME
FIREWALL SHALL BE SEPARATED BY A HORIZONTAL AND VERTICAL DISTANCE
OF NOT LESS THAN 24". THE ELECTRICAL CONTRACTOR SHALL MAKE MINOR
ADJUSTMENTS, AS NECESSARY, TO ELECTRICAL BOX LOCATIONS TO ENSURE
COMPLIANCE WITH THIS REQUIREMENT SINCE BOX LOCATIONS ARE
TYPICALLY NOT DIMENSIONED ON THE DRAWINGS. CONSULT ARCHITECT IF
CLARIFICATION IS REQUIRED.

GENERAL TERMINATION NOTES

- USE THESE TYPICAL WALL TERMINATION DETAILS FOR ALL WALLS INDICATED TO EXTEND TO DECK ABOVE, UNLESS SPECIFICALLY DETAILED OTHERWISE. COORDINATE WITH STRUCTURAL FRAMING PLANS.
- SEE WALL TYPES ABOVE FOR ACTUAL WALL CONSTRUCTION.
 AT FIRE WALLS, FIRE SEPARATION WALLS, SMOKE BARRIER WALLS AND WALLS REQUIRED TO RESIST THE PASSAGE OF SMOKE, ALL 'COMPRESSIBLE, NON-COMBUSTIBLE' MATERIALS REFERENCED IN THE WALL TERMINATION DETAILS SHALL BE MATERIALS PROVIDED IN ACCORDANCE WITH THE
- APPROVED FIRE RESISTIVE JOINT SYSTEM.

 I. IF A WALL REQUIRING A FIRE RATING IS LOCATED DIRECTLY UNDER A BEAM THE FIRE RATING OF THE WALL SHALL BE MAINTAINED TO THE DECK BY EXTENDING WALL AROUND BEAM. CONSULT ARCHITECT FOR EXACT REQUIREMENTS TO MAINTAIN RATING.



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3 07/11/2025 CONSTRUCTION DOCUMENTS
2 06/13/2025 DESIGN DEVELOPMENT
1 04/18/2025 SCHEMATIC DESIGN
NO. DATE DESCRIPTION
ISSUE

RUST MANOR INTERIOR RENOVATIONS

802 CHILDRENS CENTER RD LEESBURG, VA 20175

DRAWING TITLE:

DATE: 10/05/09

PARTITION TYPES

COMM. NO:	DRAWING NUMBER:
230210	
DRAWN:	
ANM	
CHECKED:	A600
SNM	HOUU
SCALE:	
As indicated	

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	DOOR SCHEDULE												
		LEAF FRAME HARDWARE											
NO.	ROOM/AREA	MATERIAL	FINISH	TYPE	WIDTH	HEIGHT	MATERIAL	JAMB	HEAD	THR.	FIRE RATING	SET	REMARKS
101	MEN'S RESTROOM	SCWD	PTD	F	3'-0"	7'-0"	WD	J1	H1	S2		1	
102	WOMEN'S RESTROOM	SCWD	PTD	F	3'-0"	7'-0"	WD	J1	H1	S2		1	
103	JANITOR CLOSET	SCWD	PTD	F	3'-0"	7'-0"	WD	J1	H1	S1		2	
104	PANTRY	SCWD	PTD	DA	4'-0"	7'-0"	WD	J1	H1	S1		3	
105	STORAGE	SCWD	PTD	F	3'-0"	7'-0"	WD	J1	H1	S1		4	

4 EA WALL STOP WS406/407CCV 630 IVE

2 EA MFR. STANDARD LITE

3 EA SILENCER SR64 GRY IVE

HARDWARE SETS

HDWE	E SET #1 - RESTROOM		HDWE	SET #3 - DOUBLE-ACTING
3 EA	HINGE 5BB1HW 4.5 X 4.5 652 IVE	605 SCH	2 EA	MFR. STANDARD PIVOT HINGE
1 EA	PASSAGE LOCKSET ND10 ATH-605		2 EA	MFR. STANDARD PIVOT SHOE
1 EA	WALL STOP WS406/407CCV 630 IVE		4 EA	KICK-PLATE

1EA CLOSER 1 EA KICK PLATE


3 EA SILENCER SR64 GRY IVE


DWE	SET #2 - JANITOR	HDWE SET #4 - STORAGE	HDWE SET #4 - STORAGE			
EΑ	HINGE 5BB1HW 4.5 X 4.5 652 IVE	3 EA HINGE 5BB1HW 4.5 X 4.5 652	IVE			

3 EA HINGE 5BB1HW 4.5 X 4.5 652 IVE 3 EA HINGE 5BB1HW 4.5 X 4.5 652 IVE
1 EA ACCESSIBLE STOREROOM LOCKSET ND81 ATH-605 SCH 1 EA ELECTRONIC LOCK CO-100-CY-70-KP-ATH-605-P6 SCH
3 EA SILENCER SR64 GRY IVE 1 EA WALL STOP WS406/407CCV 630 IVE

DOOR TYPES

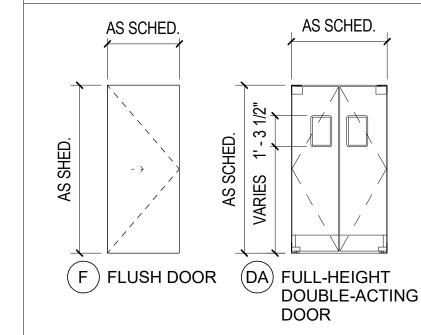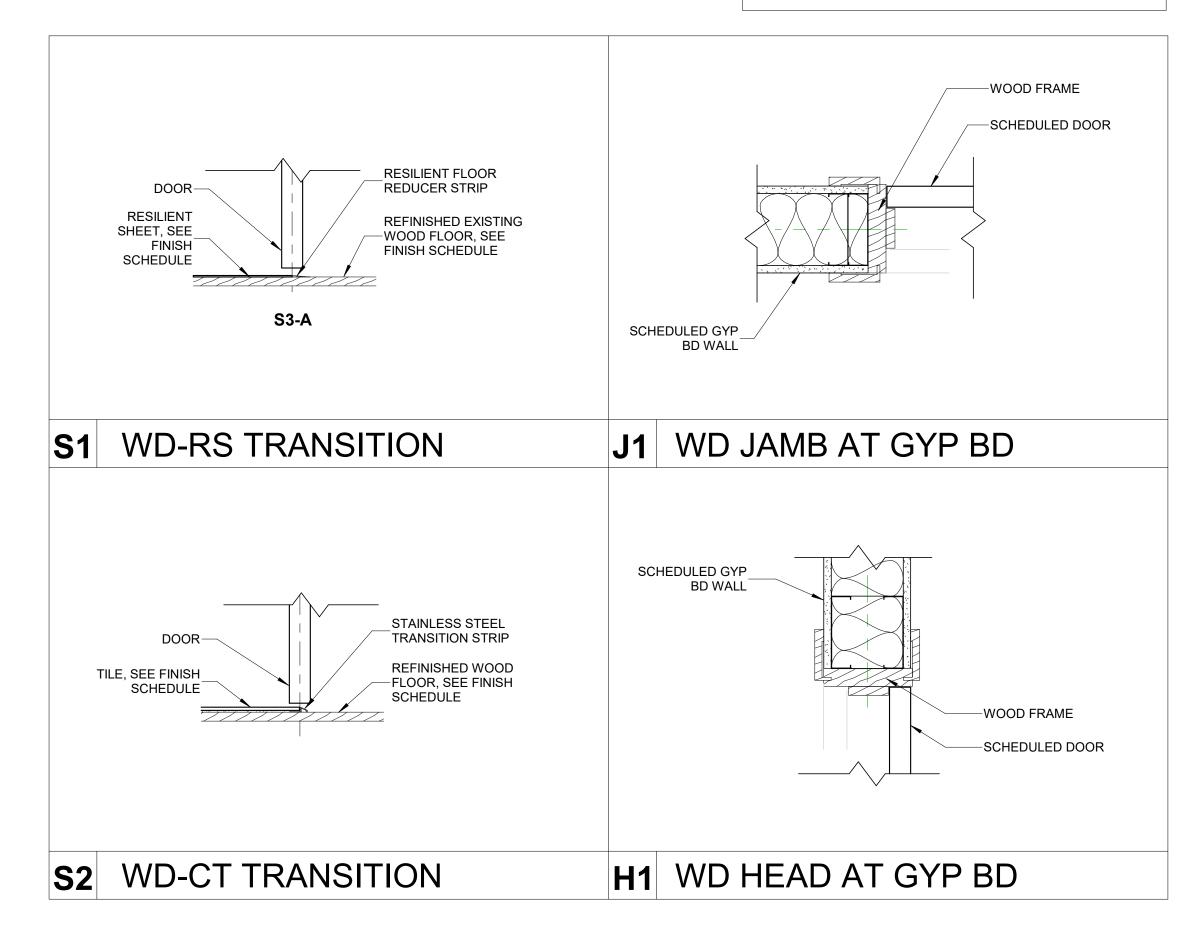605





TYPICAL DETAILS

DOORS NOT LISTED ON THE SCHEDULE SHALL HAVE THE TYPICAL FINISHES LISTED BELOW:

DOOR:
WIDTH: 3'-0" MATERIAL: HM
HEIGHT: 7'-0" TYPE: 1
THICKNESS: 1-3/4" JAMB: J1
TYPE: F HEAD: H1
MATERIAL: SCWD SILL: NONE
DOOR LABEL: NONE

TYPICAL DOOR NOTES

1. COORDINATE AND PROVIDE HARDWARE AS DETAILED IN THE SPECIFICATIONS OR, IF NOT SPECIFIED, PROVIDE HARDWARE (OF EQUAL QUALITY TO THAT SPECIFIED, AND MOST SIMILAR IN FUNCTION TO TYPE OF DOOR) REQUIRED FOR DOORS TO OPERATE AND APPEAR AS INTENDED ON DRAWINGS.

2. PROVIDE BRUSHED STAINLESS STEEL KICK PLATES ON PUSH SIDE OF DOORS WITH PUSH BARS AND/OR CLOSER DEVICES. KICK PLATE SHALL BE INSET 1/2" FROM EACH SIDE OF DOOR, AND MAXIMUM 8" HIGH OR 1/2" BELOW EDGE OF GLASS LIGHT (IF PRESENT).

PROVIDE EXPOSED HARDWARE WITH BRUSHED-IN FINISH AND "SILVER"

METALLIC IN COLOR (ALUMINUM, CHROME, OR STEEL).

4. WHEN EXPOSED CLEAR FINISHED WOOD DOORS ARE PAIRED, TAKE CARE TO SELECT MATCHING GRAIN TYPE AND COLOR FOR EACH DOOR IN PAIR.

IF CONFLICT EXISTS BETWEEN DOOR RATING AS SCHEDULED AND

WALL/PARTITION TYPE FIRE RATING AS SHOWN ON PLANS, PROVIDE DOOR(S) WITH THE GREATER FIRE RATING OF THE TWO.

6. VERIFY ALL DIMENSIONS AND CLEARANCES, AND COORDINATE UNDERCUTTING REQUIRED TO CLEAR ADJACENT FLOOR MATERIALS.

SEE FRAME ELEVATION SHEETS FOR FRAME TYPES. (BOTH H.M. AND ALUM. STOREFRONT) AND GLASS TYPE KEY.
 IF A DISCREPANCY EXISTS BETWEEN THE DOOR SCHEDULE REMARKS AND THE HARDWARE SCHEDULE IN THE SPECIFICATIONS, PROVIDE THE HARDWARE NEEDED TO MEET THE MORE STRINGENT OF THE

REQUIREMENTS.

9. SEE SPECIFICATIONS FOR SCHEDULED HARDWARE SETS. SEE
SPECIFICATIONS FOR HARDWARE SETS INDICATED FOR PACKAGED DOOR

10. PROVIDE CONTINUOUS WEATHERSTRIPPING AND DOOR BOTTOM SEALS AT EXTERIOR DOORS AS SPECIFIED.

11. ALL INTERIOR AND EXTERIOR DOORS AND FRAMES SHALL BE FACTORY PREPPED TO ACCEPT REQUIRED FINISH HARDWARE AND ELECTRONIC ACCESS CONTROL EQUIPMENT.

NOTES FOR REMARKS COLUMN

NOTE: NOT ALL NOTES MAY BE USED ON THIS PROJECT. SEE SPECIFICATIONS FOR ADDITIONAL DOOR INFORMATION. REFERENCE SPECIFICATIONS FOR DETAILED HARDWARE REQUIREMENTS.

1. PROVIDE ADA COMPLIANT CLOSER (ONE CLOSER FOR EACH DOOR OF

2. PROVIDE PANIC HARDWARE.

PROVIDE ALARMED PANIC HARDWARE.
 PROVIDE ADA AUTOMATIC SWING DOOR OPERATOR WITH PUSH BUTTON

CONTROLS AND ASSOCIATED SIGNAGE.

5. PROVIDE DOORS WITH ELECTROMAGNETIC HOLD OPEN DEVICES CONNECT TO FIRE ALARM SYSTEM TO CLOSE UPON ACTIVATION -- SEE

ELECTRICAL DRAWINGS.

6. PROVIDE WITH HOLD OPEN FEATURE IN CLOSER.

7. PROVIDE WEATHERSTRIPPING ON ALL SIDES, TOP AND BOTTOM OF DOOR.

8. PROVIDE DOOR WITH INSULATED CORE.
9. PROVIDE HARDWARE WITH PRIVACY SET.
40. PROVIDE FLUCUL POLITIC ON INVASTING LEAF.

10. PROVIDE FLUSH BOLTS ON INACTIVE LEAF.11. PROVIDE WITH PUSH / PULL OPERATION.

11. PROVIDE WITH PUSH / PULL OPERATION.

12. PROVIDE HARDWARE FOR 180 DEGREE SWING

13. DOUBLE ACTING DOOR FUNCTION.14. COILING SECURITY GRILLE.

15. PROVIDE WITH MECHANICAL PUSH BUTTON COMBINATION LOCK.
16. PROVIDE WITH CARD READER AND ASSOCIATED HARDWARE.
17. SECURITY SYSTEM DOOR SWITCH AT HM FRAME - COORDINATE WITH

ELECTRICAL.

18. PROVIDE WITH MAGNETIC LOCKS AND OPEN RELEASE BUTTON - CONNECT TO FIRE ALARM SYSTEM TO OPEN UPON ACTIVATION - SEE ELECTRICAL DRAWINGS

GLASS TYPES & NOTES

 $\underline{\mathsf{GLASS}}\,\, \underline{\mathsf{TYPES}}\,\, (\mathsf{NOTE};\, \mathsf{NOT}\,\, \mathsf{ALL}\,\, \mathsf{TYPES}\,\, \mathsf{MAY}\,\, \mathsf{BE}\,\, \mathsf{USED}\,\, \mathsf{ON}\,\, \mathsf{THIS}\,\, \mathsf{PROJECT}.)$

G1 1/4" TEMPERED GLASS

G2 INSULATED TEMPERED GLASS (1/8" TEMP+ AIRSPACE +1/8" TEMP).

G3 INSULATED GLASS (1/8" GLASS+ AIRSPACE +1/8" GLASS).

G4 FIRE RATED GLASS ('FIRELITE' BY TGP OR EQUAL)

GLASS NOTES:

1. MAXIMUM GLASS AREA, EACH LITE, IN 3/4 HR RATED FRAME ASSEMBLIES IS

2. MAXIMUM HEIGHT AND WIDTH FOR 3/4 HR RATING IS 54".

3. MAXIMUM GLASS AREA, EACH LITE, IN 1-1/2 HR RATED FRAME ASSEMBLIES

4. MAXIMUM HEIGHT AND WIDTH FOR 1-1/2 HR RATING IS 33" H AND 10" W.

5. ALL DOORS INTO EGRESS AREAS SUCH AS STAIRS THAT CONTAIN GLAZING, SHALL HAVE LABELED FIRE RESISTANT RATED GLASS TYPE G4

6. ALL GLAZING ON EXTERIOR, NON-RATED WALLS OF EGRESS STAIRS SHALL BE LABELED SAFETY GLAZING.

DOOR & FRAME MATERIAL KEY

DOOR MATERIAL

SCWD SOLID CORE WOOD

VD HOLLOW CORE WOOD / HARD BOARD

HM HOLLOW METAL

MC METAL CLAD

MANUF. BY MANUFACTURER

FIBERGLASS

FRAME MATERIAL:

MTL ADJUST-A-FIT METAL FRAME
HM HOLLOW METAL
WD PRE-HUNG WOOD
F FIBERGLASS
MANUF. BY MANUFACTURER

2 07/11/2025 CONSTRUCTION DOCUMENTS
1 06/13/2025 DESIGN DEVELOPMENT
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Alexandria, Virginia 22314

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RUST MANOR INTERIOR RENOVATIONS

802 CHILDRENS CENTER RD LEESBURG, VA 20175

DRAWING TITLE:

As indicated

DATE: 10/05/09

DOOR SCHEDULE AND DETAILS

COMM. NO: 230210

DRAWN: SNM

CHECKED: SNM

SCALE:

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FINISH SCHEDULE									
	ROOM				W	ALLS			
ROOM NAME	NUMBER	FLOOR	BASE	Α	В	С	D	CLG. MATL.	REMARKS
1ST FLOOR							•		
HALLWAY	100	WD	RB	CT-2	PTD	PTD	PTD	GWB	
MEN'S RESTROOM	101	PT	PBT	PTD	PTD	PTD	PTD	GWB	
WOMEN'S RESTROOM	102	PT	PBT	PTD	PTD	PTD	PTD	GWB	
JANITOR CLOSET	103	RS	RB	PTD	PTD	PTD	PTD	GWB	
PANTRY	104	RS	RS	CT-1	CT-1	CT-1	CT-1	GWB	
STORAGE	105	RS	RB	PTD	PTD	PTD	PTD	GWB	





TYPICAL FINISHES

SPACES NOT LISTED ON THE SCHEDULE SHALL HAVE THE TYPICAL FINISHES LISTED BELOW:

FLOORS: WD BASE: RB

WALLS: PTD

CEILING: GWB GYP. BD. ABOVE H.M. FRAMES AS INDICATED ON SECTIONS. DETAILS TO RECEIVE SAME TOP COATS AS ADJACENT WALLS UNLESS OTHERWISE NOTED.

FINISH PLAN LEGEND

FLOOR FINISH KEY

PT (PORCELAIN TILE) DALTILE SS72 TUNDRA SAND
WD (WOOD FLOOR) REFINISH EXISTING WOOD FLOOR
RS (RESILIENT SHEET) POLYSAFE VERONA PUR 5231 ROCK SALT

WALL BASE KEY

PBT (PORCELAIN BASE) MATCH FLOOR

RB (RUBBER BASE) COMMUNITY SUBURBAN 2100 BROWN
RS (RESILIENT SHEET COVE BASE) POLYSAFE VERONA PUR 5231 ROCK SALT

WALLS

PTD (PAINTED) BEHR YL-W10 NIGHT BLOOMING JASMINE

CT-1 (CERAMIC TILE) DALTILE 0100 WHITE

CT-2 (CERAMIC TILE ACCENT) DALTILE 4 X 12 WAVE CREST MY94 CYCLADE

CEILINGS

GWB SUSPENDED GWB

METAL LAMINATES

PL-1 LAMINATE - WILSONART 4830 SATIN STAINLESS

TYPICAL NOTES

- . REFER TO FLOOR PLANS, CEILING PLANS, INTERIOR ELEVATIONS, SECTIONS AND DETAILS FOR ADDITIONAL INFORMATION AND EXTENT OF EACH FINISH WHEN MORE THAN ONE FINISH IS INDICATED FOR ANY
- 2. SEE CEILING PLANS FOR HEIGHTS OF CEILINGS AND LOCATIONS AND
- HEIGHTS OF BULKHEADS, SOFFITS, ETC. 3. WHERE CERAMIC TILE IS INDICATED, INSTALL CERAMIC TILE COVE BASE FLUSH WITH FLOOR TILE AND FLUSH WITH CERAMIC WALL TILE.
- . FIELD PAINT ALL EXPOSED, NON-FACTORY FINISHED STRUCTURAL, MECHANICAL, OR ELECTRICAL COMPONENTS.
- 5. PROVIDE SEALANT AT INTERSECTIONS OF DISSIMILAR MATERIALS, COMPLYING WITH SPECIFICATIONS.

 6. REFER TO INTERIOR ELEVATIONS AND SECTIONS FOR ADDITIONAL FINISH
- INFORMATION. PROVIDE ALL FINISH MATERIALS SHOWN IN PLANS, ELEVATIONS OR SECTIONS AS NOTED OR DEPICTED ON THE DRAWINGS AND SPECIFICATIONS.
- BRING CONFLICTS TO THE ARCHITECTS ATTENTION DURING THE BIDDING PERIOD FOR CLARIFICATION.
- 8. WALL AND CEILING FINISHES SHALL INCLUDE ALL PROJECTIONS, BEAM ENCLOSURES, RECESSES, BULKHEADS, MATERIAL CHANGES, OR OTHER
- 9. ELECTRICAL OUTLETS, CLOCKS, P.A. SPEAKERS OR OTHER DEVICES SHOWN ON THE ARCHITECTURAL DRAWINGS SERVE TO CALL ATTENTION TO THE PRESENCE OF SUCH DEVICES. NOT ALL DEVICES MAY BE SHOWN ON ARCHITECTURAL DRAWINGS. CONSULT THE OTHER DRAWINGS FOR FURTHER INFORMATION AND ADVISE ARCHITECT OF ANY CONFLICT OF LOCATION OR TYPE OF DEVICES SHOWN. COORDINATE ALL WORK,
- FINISHES AND DEVICES. 10. PROVIDE MOISTURE RESISTANT GYPSUM BOARD AT TOILET ROOMS, & SERVICE CLOSETS FOR WALLS DESIGNATED AS GYPSUM BOARD WALL TYPES. PROVIDE TILE BACKER BOARD AT WALLS DESIGNATED AS GYPSUM BOARD WALL TYPES WITH TILE FINISH.
- 11. FIELD PAINT ELECTRICAL PANELS EXCEPT PANELS LOCATED IN
- ELECTRICAL CLOSETS AND MECHANICAL ROOMS. 12. BRING CONFLICTS BETWEEN THE FINISH SCHEDULE AND MATERIALS SHOWN ON OTHER DRAWINGS (AND/OR SPECIFICATIONS) TO THE ATTENTION OF THE ARCHITECT IMMEDIATELY. IF A CONFLICT EXISTS IN/BETWEEN DRAWINGS (AND/OR SPECIFICATIONS), THE MORE STRINGENT AND MORE COSTLY REQUIREMENT SHALL APPLY.



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3	07/11/2025	CONSTRUCTION DOCUMENTS				
2	06/13/2025	DESIGN DEVELOPMENT				
1	04/18/2025	SCHEMATIC DESIGN				
10.	DATE	DESCRIPTION				
SSU	SSUE					

RUST MANOR INTERIOR RENOVATIONS

802 CHILDRENS CENTER RD LEESBURG, VA 20175

DRAWING TITLE:

FINISH SCHEDULE AND **DETAILS**

COMM. NO: 230210	DRAWING NUMBER:
DRAWN:	
Author	
CHECKED:	1 1 1 1 1 1 1 1 1 1
Checker	A602
SCALE:	
As indicated	
DATE:	
10/05/09	

ELECTRICAL SPECIFICATIONS

- IN THE EVENT THAT ANY OWNER FURNISHED EQUIPMENT, DEVICES, OR MATERIAL BECOMES DAMAGED AFTER RECEIPT FROM OWNER, THE CONTRACTOR SHALL REPLACE THE EQUIPMENT AT NO ADDITIONAL COST TO THE
- 2. ALL SWITCHES, RECEPTACLES, AND TELEPHONE/DATA OUTLETS SHOWN ON THE DRAWINGS IN THE SAME LOCATION SHALL BE INSTALLED IN MULTIPLE GANG BOXES MOUNTED IN A COMMON COVER PLATE UNLESS NOTED OTHERWISE. POWER SYSTEMS SHALL NOT BE INSTALLED IN THE SAME BOX WITH TELEPHONE/DATA. THE CONTRACTOR SHALL PROVIDE DIVIDER AS REQUIRED BY LOCAL CODES.
- 3. DISCONNECT SWITCHES SHALL BE SQUARE D HEAVY DUTY, ENCLOSED SAFETY SWITCHES. SWITCHES SHALL BE OF THE QUICK-MAKE. QUICK-BREAK TYPE WITH INTERLOCKING COVERS AND STEEL BOXES OF THE TYPE ENCLOSURE REQUIRED FOR EACH LOCATION.
- 4. PANEL BOARDS SHALL BE SQUARE D 'NQOD' FOR 240VAC MAXIMUM, SQUARE D "NF" FOR 480 / 277VAC. 400A MAXIMUM, SQUARE D 'I-LINE' FOR 600 VAC, 600A TO 1200A, MOLDED CASE, WITH BOLT-ON, BRANCH CIRCUIT BREAKERS AND COPPER BUSS . SIEMENS, CUTLER HAMMER WILL BE CONSIDERED. PANEL BOARDS SHALL BE MOUNTED IN A STEEL CABINET, FLUSH OR SURFACE MOUNTED AS SHOWN ON DRAWINGS . CABINETS SHALL BE BUILT OF MATERIAL NOT THINNER THAN NO. 12 GAUGE SHEET STEEL AND LARGE ENOUGH TO CONTAIN THE PANELS AND ALLOW MINIMUM OF 4" GUTTER SPACE ALL AROUND. PROVIDE A TYPEWRITTEN DIRECTORY INSIDE EACH PANEL INDICATING THE FUNCTION AND LOCATION OF OUTLETS SERVING EACH CIRCUIT. ALL NEW PANELS SHALL PROVIDE SUFFICIENT SPACE WITHIN THE PANEL ENCLOSURES TO ALLOW FOR CHECK METERING PROVISIONS AS REQUIRED BY ASHRAE 90.1/2007 ARTICLE 5.4. PANELS SHALL BE SUPPLIED WITH 200% RATED NEUTRALS. ALL PANEL BOARD LUGS SHALL ACCOMMODATE THE INDICATED CONDUCTOR SIZES.
- 5. CIRCUIT BREAKERS SHALL BE MOLDED CASE, THERMAL-MAGNETIC QUICK-MAKE, QUICK-BREAK, BOLT-ON TYPE WITH MANUALLY OPERATED INSULATED TRIP-FREE HANDLE. MULTI-POLE TYPES WITH INTERNAL COMMON TRIP BAR. TERMINAL SUITABLE FOR COPPER CONDUCTORS.
- 6. THE CONTRACTOR SHALL BE RESPONSIBLE FOR CORRECTLY PHASING THE CIRCUITS IN THE PANEL BOARDS. UNLESS NOTED OTHERWISE, THREE SINGLE-PHASE CIRCUITS MAY BE COMBINED IN ONE CONDUIT WITH A COMMON NEUTRAL, PROVIDED EACH CIRCUIT IS ON AN OPPOSITE PHASE.
- 7. ALL CONDUCTORS SHALL BE IDENTIFIED BY COLOR AS INDICATED IN THE COLOR CODE CHART.

SYSTEM	PHASE			NEUTRAL	GROUND
SISILIVI	Α	В	С		
120/208V	BLACK	RED	BLUE	WHITE	GREEN
277/480V	YELLOW	BROWN	ORANGE	GRAY	GREEN

- 8. ALL CONDUCTORS LESS THAN 100A SHALL BE COPPER WITH TYPE THW OR THHN (DRY LOCATION ONLY) 60
- 9. ALL CONDUCTORS OVER 100A SHALL BE COPPER WITH TYPE THW OR THHN (DRY LOCATION ONLY) 75 DEGREE C INSULATION.
- 10. ALL 20 AMP CONDUCTORS SHALL BE NO. 12 AWG COPPER MINIMUM UNLESS NOTED OTHERWISE.
- 11. ROUTE RACEWAYS CONCEALED BEHIND OR ABOVE BUILDING FINISHES UNLESS OTHER WISE NOTED. ELECTRIC METALLIC TUBING (EMT), THIN WALL PIPE, GALVANIZED, MINIMUM 3/4" EXCEPT AS NOTED OR REQUIRED FOR WIRING. ALL FITTINGS AND COUPLINGS SHALL BE STEEL. BELOW GRADE: MINIMUM 1", SCHEDULE 40 PVC OR RIGID GALVANIZED STEEL CONDUIT.
- 12. THE CONTRACTOR SHALL PROVIDE POWER, TELE/DATA EMPTY CONDUIT/EMT WITH PULL STRING FROM WALL LOCATION TO CEILING SPACE.
- 13. ALL 120V/208V HOMERUNS LONGER THAN 75'-0" SHALL BE ADJUSTED FOR SIZE THAN REQUIRED/INDICATED FOR THE AMPERAGE FOR THE EQUIPMENT AND ALL 277V/480V HOMERUNS LONGER THAN 150'-0" SHALL ADJUSTED FOR SIZE THAN REQUIRED/INDICATED FOR THE AMPERAGE OF THE EQUIPMENT. (3% VOLTAGE DROP).
- 14. ALL 120V/208V FEEDERS LONGER THAN 75'-0" SHALL BE ADJUSTED FOR SIZE THAN REQUIRED/INDICATED FOR THE AMPERAGE FOR THE EQUIPMENT AND ALL 277V/480V FEEDERS LONGER THAN 150'-0" SHALL ADJUSTED FOR SIZE THAN REQUIRED/INDICATED FOR THE AMPERAGE OF THE EQUIPMENT. (2% VOLTAGE DROP).
- 15. RECEPTACLES MOUNTED IN GARAGE SHALL BE GROUND FAULT INTERRUPTER (GFI) TYPE.
- 16. ALL WIRING SHALL BE COPPER CONDUCTORS UNLESS NOTED OTHERWISE. ALL WIRING #10 AND LESS SHALL BE
- 17. THE CONTRACTOR SHALL BE RESPONSIBLE FOR PROPER SIZING OF ALL MOTOR OVERLOAD DEVICES (HEATERS) IN STARTERS BASED ON ACTUAL NAMEPLATE RATINGS ON THE MOTORS BEING INSTALLED.
- 18. THE CONTRACTOR SHALL NOTE U.L. LABEL/NAMEPLATE ON ELECTRICAL EQUIPMENT, OR IF THE LOCAL INSPECTOR REQUIRES THE OVERLOAD PROTECTIVE DEVICES TO BE FUSED, THE ELECTRICAL CONTRACTOR SHALL PROVIDE A FUSED DISCONNECT SWITCH WITH PROPER SIZE FUSES AT THE SWITCH LOCATION AS INDICATED ON THE DRAWINGS.
- 19. ALL DUPLEX RECEPTACLES ON DEDICATED CIRCUITS SHALL BE NEMA 5-20R, UNLESS NOTED OTHERWISE.
- METALLIC CONDUIT WITH CONDUCTORS SHALL BE USED IN LIEU OF CABLE IN ALL VISIBLE PUBLIC AREAS AND BACK OF HOUSE LOCATIONS.

20. NEW DIRECTORY CARDS FOR EACH PANELBOARD SHALL BE PROVIDED AT COMPLETION OF WORK WITH TYPED

- DESIGNATIONS INDICATING NAME, VOLTAGE, PHASE, ETC. AND FINAL CIRCUITING DEPICTING EACH POLE POSITION IN A TWO COLUMN FASHION. ROOM NUMBERS SHALL BE USED WHENEVER POSSIBLE ON CIRCUIT
- 21. AFTER FINAL INSTALLATION, THE CONTRACTOR SHALL BE RESPONSIBLE FOR FILLING ALL VOIDS AROUND CONDUIT PENETRATIONS AND OTHER CORE DRILLS/OPENINGS IN SLAB WITH A FIRE SAFING REMOVABLE MASTIC. FILL SHALL EQUAL FIRE RATING OF FLOOR.
- 22. ALL BALLASTS SHALL BE ELECTRONIC AND RATED FOR THE LAMP IT OPERATES. LAMPS SHALL BE ENERGY SAVING TYPE.
- 23. INTERNALLY ILLUMINATED EXIT SIGNS SHALL NOT EXCEED 5 WATTS PER SIDE AND SHALL BUILT IN BATTERY BACK UP LASTING UP TO 90 MINUTES.
- 24. THERMOSTATS, DAMPERS OR OTHER ACTUATORS AND CONTROL EQUIPMENT. CONTROL SYSTEMS FOR NEW ELECTRICAL SYSTEMS SHALL BE COMPLETE AND OPERATIONAL. COUPLINGS AND FITTINGS FOR EMT SHALL BE OF STEEL (CAST POT METAL IS NOT ACCEPTABLE) AND SHALL BE OF THE COMPRESSION OR SET STEEL SCREW
- 25. ALL CONDUITS SHALL BE RIGIDLY SUPPORTED TIGHT TO THE BUILDING STRUCTURE. THE MAXIMUM SPACING OF SUPPORTS SHALL BE 10'-0" FOR VERTICAL RUNS AND 8'-0" FOR HORIZONTAL RUNS.
- 26. ALL FUSES SHALL BE DUAL-ELEMENT LOW PEAK AS MANUFACTURED BY BUSSMAN (LPN) OR LITTLE FUSE.
- 27. CONDUIT/CABLE SHALL BE PROVIDED AS FOLLOWS:

ALL CONNECTIONS TO MOTORS SHALL BE U.L. LISTED

MOTORS: LIQUID TIGHT FLEX. (MINIMUM 24" LONG).

EXPOSED INTERIOR: ALL EXPOSED INTERIOR WIRING SHALL BE IN GALVANIZED STEEL OR ALUMINUM EMT WITH STEEL SET SCREW CONNECTORS.

CABLE: BRANCH CIRCUIT WIRING CONCEALED IN A WALL OR CEILING CONNECTING RECEPTACLES AND LIGHTS MAY BE 'MC' CABLE.

- 28. ALL JUNCTION BOXES SHALL BE MARKED WITH CIRCUIT NUMBERS, PANEL DESIGNATION AND VOLTAGE.
- 29. SUBMIT SHOP DRAWING FOR EQUIPMENT AND LIGHT FIXTURES FOR APPROVAL.

ELECTRICAL GENERAL NOTES

- ALL ELECTRICAL WORK SHALL COMPLY WITH THE 2020 NATIONAL ELECTRICAL CODE (N.E.C.), THE LIFE SAFETY CODE, 2021 INTERNATIONAL ENERGY CONSERVATION CODE, AND IN ACCORDANCE WITH ALL APPLICABLE STATE CODE REQUIREMENTS AND LOCAL AUTHORITIES.
- 2. OBTAIN AND PAY FOR ALL PERMITS ASSOCIATED WITH THIS PROJECT PRIOR TO STARTING OF WORK AND ARRANGE ALL REQUIRED INSPECTIONS BY THE APPROPRIATE LOCAL AUTHORITIES.
- 3. ALL ELECTRICAL EQUIPMENT SHALL BE UNDERWRITERS LABORATORY (U.L.) LABELED OR LABELED BY AN APPROVED ACCREDITED AGENCY AND TESTING ORGANIZATION.
- 4. PROVIDE COMPLETE AND PROPERLY FUNCTIONING ELECTRICAL SYSTEMS FOR THIS PROJECT. VISIT THE PROJECT SITE. EXAMINE THESE PLANS AND ALL EXISTING DRAWINGS RELATING TO THE AREA OF WORK, AND REPORT ANY DISCREPANCIES OR OMISSIONS IN THIS PLAN SET TO THE ENGINEER FOR RESOLUTION AND CLARIFICATION PRIOR TO SUBMISSION OF BIDS. BY SUBMITTING A BID ON THIS PROJECT, THE CONTRACTOR ACCEPTS THESE DOCUMENTS AS AN ADEQUATE DEFINITION OF THE SCOPE OF WORK. CLAIMS FOR ADDITIONAL COSTS TO ACHIEVE THE INTENDED SCOPE OF WORK WILL NOT BE ACCEPTED.
- 5. ALL WORK SHOWN ON THESE DOCUMENTS IS NEW.
- 6. IT IS THE INTENT OF THE CONTRACT DOCUMENTS TO INDICATE FINISHED WORK THAT IS FULLY ADJUSTED, TESTED, AND READY FOR OPERATION. WHEREVER THE WORD "PROVIDE" IS USED. IT SHALL MEAN "FURNISH AND INSTALL COMPLETE AND READY FOR USE", UNLESS NOTED OTHERWISE.
- 7. THE CONTRACTOR SHALL FURNISH, INSTALL, WIRE, CONNECT, AND ENERGIZE THE COMPLETE FUNCTIONAL SYSTEMS REQUIRED, INCLUDING EQUIPMENT, DEVICES, WIRING, AND ALL OTHER APPURTENANCES AND HARDWARE FOR A COMPLETE SYSTEM.
- 8. THE CONTRACTOR SHALL FURNISH AND INSTALL ALL ITEMS NECESSARY FOR THE COMPLETE INSTALLATION OF THE EQUIPMENT AS REQUIRED BY CODE WITHOUT ADDITIONAL COST TO THE OWNER, REGARDLESS WHETHER THE ITEMS ARE INDICATED IN THE CONTRACT DRAWINGS OR SPECIFICATIONS. SUCH ITEMS COULD BE, BUT ARE NOT LIMITED TO, SUPPORTS, WIRING, START-UP AND SERVICE, ETC.
- 9. THE CONTRACTOR SHALL PROVIDE AND INSTALL A FIRST CLASS SYSTEM AND SHALL COMPLETELY COORDINATE WITH ALL OTHER TRADES.
- 10. ALL CONFLICTS WHICH MAY PREVENT THE COMPLETION OF WORK SHALL BE BROUGHT TO THE ATTENTION OF THE OWNER'S REPRESENTATIVE. THE CONTRACTOR SHALL NOT PROCEED WITH RELATED WORK UNTIL THE CONFLICT IS RESOLVED.
- 11. THE CONTRACTOR SHALL INSTALL ALL ELECTRICAL AND ELECTRICAL EQUIPMENT IN ACCORDANCE WITH MANUFACTURERS RECOMMENDATIONS.
- 12. ALL EQUIPMENT, DEVICES, AND RELATED APPURTENANCES SHALL BE THE LATEST PRODUCT OF THE SPECIFIED MANUFACTURERS UNLESS NOTED OTHERWISE.
- 13. THE CONTRACT DRAWINGS ARE DIAGRAMMATIC AND DO NOT INDICATE ALL COMPONENTS AND ACCESSORIES REQUIRED FOR THE COMPLETE INSTALLATION. THE CONTRACTOR SHALL PROVIDE SUCH ITEMS TO COMPLETE THE ENTIRE SYSTEM AND PLACE IN PROPER OPERATION IN ACCORDANCE WITH APPLICABLE CODES, INDUSTRY STANDARDS, AND EQUIPMENT MANUFACTURER'S RECOMMENDATIONS.
- 14. LOCATIONS OF EQUIPMENT, LIGHTING FIXTURES, DEVICES, ETC. ARE INDICATED DIAGRAMMATICALLY ON THE DRAWINGS. THE CONTRACTOR SHALL OBTAIN EXACT LOCATIONS AND ESTABLISH EXACT DIMENSIONS ON THE JOB SITE AFTER STUDYING THE CONDITIONS.
- 15. THE CONTRACTOR SHALL REFER TO THE ARCHITECTURAL DRAWINGS FOR EXACT LOCATIONS. MOUNTING METHODS, AND DIMENSIONS OF LIGHT FIXTURES, LIFE SAFETY DEVICES, CEILING DEVICES, RECEPTACLES, TELEPHONE AND DATA OUTLETS, AND OTHER ITEMS VISIBLE IN PUBLIC AREAS.
- 16. THE CONTRACTOR SHALL INSTALL ALL ELECTRICAL SYSTEMS SO AS TO NOT INTERFERE WITH THE PLUMBING, STRUCTURAL, ELECTRICAL, AND ARCHITECTURAL SYSTEMS.
- 17. ALL ELECTRICAL SYSTEMS, DEVICES, AND RELATED ITEMS SHALL BE TESTED AT THE COMPLETION OF THE PROJECT. THE CONTRACTOR SHALL REPLACE ANY AND ALL DEFECTIVE DEVICES, ITEMS, OR SYSTEMS AT COMPLETION OF THE PROJECT.
- 18. ANY EQUIPMENT INCLUDING TELEPHONE/DATA CABLE LOCATED WITHIN A RETURN AIR PLENUM SHALL BE RATED FOR SUCH APPLICATION IN ACCORDANCE WITH APPLICABLE REGULATIONS.
- 19. THE CONTRACTOR SHALL PERFORM THE FOLLOWING EQUIPMENT CONNECTIONS AS REQUIRED BY THE EQUIPMENT OR AS INDICATED IN THE CONTRACT DOCUMENTS: EXTEND AND CONNECT TO EQUIPMENT; MOUNT AND CONNECT TO STARTERS; INSTALL PUSH BUTTON STATION AND THERMAL OVERLOAD SWITCHES: FURNISH SUITABLE RECEPTACLES. PLUG. COVER PLATE. CORD, ARMORED CABLE, WIRE, DIRECT CONNECTIONS, DISCONNECT SWITCHES, ETC.
- 20. ALL WORK SHALL BE PERFORMED IN A SUCH MANNER TO CREATE MINIMAL POWER OUTAGES FOR THE OWNER. ALL SUCH OUTAGES SHALL BE CAREFULLY COORDINATED WITH THE OWNER SO THAT POWER TO ESSENTIAL SERVICES CAN BE MAINTAINED.
- 21. THE ELECTRICAL CONTRACTOR SHALL FURNISH AND INSTALL MOTOR STARTERS FOR ELECTRICAL EQUIPMENT AND THE EQUIPMENT SHALL BE WIRED BY THE ELECTRICAL
- 22. EXACT LOCATION AND MOUNTING HEIGHTS OF JUNCTION BOXES, OUTLETS, STUB-UPS, ETC. SHALL BE DETERMINED FROM CONTRACT DOCUMENTS, EQUIPMENT, DETAILS, SPECIFICATIONS WHERE APPLICABLE, AND MANUFACTURER'S ROUGH-IN DRAWINGS.COORDINATE MOUNTING HEIGHT WITH ARCHITECT PRIOR TO INSTALLATION.
- 23. ALL LIGHTING FIXTURE LOCATIONS SHALL BE COORDINATED WITH THE REFLECTED CEILING PLANS, ARCHITECTURAL SECTIONS AND DETAILS, ELECTRICAL AND PLUMBING DRAWINGS AND SYSTEMS. SHOULD A DISCREPANCY ARISE, NOTIFY THE OWNER'S REPRESENTATIVE IMMEDIATELY.
- 24. ELECTRICAL EQUIPMENT REQUIRING ACCESS SUCH AS JUNCTION BOXES, POWER PACKS, DOWNLIGHT BALLASTS AND CONNECTIONS TO EQUIPMENT, ETC. SHALL NOT BE INSTALLED ABOVE INACCESSIBLE CEILINGS OR BEHIND WALLS. PROVIDE ACCESS PANEL OF ADEQUATE SIZE TO FACILITATE THE REMOVAL AND SERVICE OF THE EQUIPMENT.
- 25. ALL CONDUITS AND RACEWAYS SHALL BE RUN CONCEALED IN WALLS OR ABOVE CEILING UNLESS OTHERWISE NOTED.
- 26. ALL GROUNDING SHALL BE DONE AS PER N.E.C. REQUIREMENTS. THE CONTRACTOR SHALL USE GREEN GROUND WIRE FOR GROUNDING.
- 27. ALL BRANCH CIRCUIT WIRING ON THE DRAWINGS THAT IS UNMARKED INDICATES TWO CURRENT CARRYING CONDUCTORS AND A GROUNDING CONDUCTOR.
- 28. THE ACTUAL NUMBER OF WIRES FOR EACH CIRCUIT ARE NOT INDICATED ON THE DRAWINGS UNLESS NECESSARY FOR CLARIFICATION. THE ELECTRICAL CONTRACTOR SHALL PROVIDE ALL WIRES NECESSARY FOR THE PROPER FUNCTION OF THE SYSTEM WHETHER INDICATED ON THE DRAWINGS OR NOT.
- 29. PROVIDE NFPA APPROVED FIRE STOPPING AT ALL PIPING AND CONDUIT PENETRATIONS OF FIRE RATED FLOORS, WALLS, AND COMPONENTS.
- 30. ANY CIRCUITS AVAILABLE TO NEW BUILD OUT THAT ARE NOT USED SHALL BE DEMOED BACK TO PANEL AND MARKED AS SPARE.
- 31. DO NOT SUPPORT LIGHT FIXTURES FROM CEILING GRID. PROVIDE SUPPORT ON ALL FOUR CORNERS FROM STRUCTURE ABOVE.
- 32. REFER TO SPECIFICATIONS FOR MORE INFORMATION.

	ABBREVIATION
BBREVIATION	DESCRIPTION
ABV A OR AMP	ABOVE AMPERE
AFF	ABOVE FINISHED FLOOR
AIC	ASYMMETRICAL INTERRUPT CURRENT
AS	AUXILIARY SOUND
ATC	AUTOMATIC TEMPERATURE CONTROL
AWG	AMERICAN WIRE GAUGE
BEL	BELOW
C	CONDUIT
C/B CATV	CIRCUIT BREAKER CABLE TELEVISION
CKT	CIRCUIT
CTR	COUNTER
CLG	CEILING
C/T	CURRENT TRANSFORMER
CW	COOL WHITE
DED	DEDICATED
DEF DN	DUAL ELEMENT FUSES DOWN
DTT	DOUBLE TWIN TUBE
DWG	DRAWING DRAWING
EA	EACH
ECB	ENCLOSED CIRCUIT BREAKER
EG	EQUIPMENT GROUND
EXH	EXHAUST
EW	EMERGENCY WHITE
EWC FA	FIRE ALARM
FLA	FULL LOAD AMPS
FLR	FLOOR
FSS	FUSED SAFETY SWITCH
GFI	GROUND FAULT INTERRUPTER
GBB	GROUNDING AND BONDING BAR
HID	HIGH INTENSITY DISCHARGE
HP	HORSEPOWER
HZ IG	HERTZ ISOLATED GROUND
J-BOX; JB	JUNCTION BOX
К	THOUSAND
KW	KILOWATT
LCC	LIGHTING CONTROL CENTER
LTS	LIGHTS
MAX MCA	MAXIMUM MINIMUM CIRCUIT AMPACITY
MCB	MAIN CIRCUIT BREAKER
MDP	MAIN DISTRIBUTION PANEL
MIN	MINIMUM
MLO	MAIN LUGS ONLY
MOCP	MAXIMUM OVERCURRENT PROTECTION
NEC	NATIONAL ELECTRIC CODE
NF	NON-FUSIBLE
NFSS NIC	NON-FUSED SAFETY SWITCH NOT IN CONTRACT
NL	NIGHT LIGHT
Р	POLES
PNL	PANEL
REC	RECEPTACLE
RR	RESTROOM
RM	ROOM
TEL TYP	TELEPHONE TYPICAL
UC	UNDER COUNTER
UG	UNDERGROUND
UON	UNLESS OTHERWISE NOTED
V	VOLTS
W	WATTS
W/	WITH
WP	WEATHERPROOF
WW	WARM WHITE PHASE
Ø or Ph	
V W W/ WP	VOLTS WATTS WITH WEATHERPROOF WARM WHITE

SYMBOL	DESCRIPTION
\$	SINGLE POLE FLUSH TUMBLER SWITCH MOUNTED 4'-0" ABOVE FINISHED FLOOR, UNLESS OTHERWISE NOTED ON DRAWINGS
\$3 \$4 \$D	THREE OR FOUR WAY FLUSH TUMBLER SWITCH, D-DIMMER, MOUNTING HEIGHT 4'-0" ABOVI FINISHED FLOOR, UNLESS OTHERWISE NOTED ON DRAWINGS.
Φ	120/277V WALL MOUNTED MOUNTED DUAL TECH W/MICROPHONICS VACANCY SENSOR.
М	CEILING MOUNTED MOTION SENSOR.
DS	DAY LIGHT SENSOR
PP	POWER PACK. WATT STOPPER BZ-50.
	LINEAR LIGHT FIXTURE
0	RECESSED DOWNLIGHT
□	VANITY LIGHT FIXTURE
	ROUND LIGHT FIXTURE
⊢∭ ^{EM}	LED EMERGENCY LIGHT FIXTURE
⊗ \$ H	EXIT SIGN LIGHTING FIXTURE CEILING OR WALL MOUNTED, DIRECTIONAL ARROWS AS INDICATED ON PLANS. EXIT SIGN SHALL BE EQUIPPED WITH EMERGENCY BATTERY BACK-UP.
	COMBINATION EXIT SIGN LIGHTING FIXTURE AND BATTERY PACK; CEILING OR WALL MOUNTED.
	WALL/CEILING MOUNTED BATTERY PACK
\rightleftharpoons	DUPLEX RECEPTACLE, 2P, 3W, 20A, 125V, NEMA 5-20R, FLUSH MOUNTED 18" ABOVE FINISHED FLOOR, UNLESS OTHERWISE NOTED ON DRAWINGS
	DUPLEX RECEPTACLE, 2P, 3W, 20A, 125V, NEMA 5-20R, FLUSH MOUNTED. INSTALL 6" ABOVE COUNTER HEIGHT. COORDINATE COUNTER HEIGHT WITH OWNER.
#	QUADRUPLEX RECEPTACLE 2P, 3W, 20A, 125V, NEMA 5-20R
***	QUADRUPLEX RECEPTACLE 2P, 3W, 20A, 125V, NEMA 5-20R, FLUSH MOUNTED 6" ABOVE COUNTER. COORDINATE COUNTER HEIGHT WITH ARCHITECT.
$\overline{\bullet}$	DUPLEX GFI RECEPTACLE, 2P, 3W, 20A, 125V, NEMA 5-20R, FLUSH MOUNTED. COORDINATE EXACT LOCATION WITH ARCHITECT.
	DUPLEX GFI RECEPTACLE, 2P, 3W, 20A, 125V, NEMA 5-20R, FLUSH MOUNTED 6" ABOVE COUNTER. COORDINATE COUNTER HEIGHT WITH ARCHITECT.
\bigotimes	SPECIAL RECEPTACLE. COORDINATE WITH EQUIPMENT SUPPLIED FOR NEMA CONFIGURATION AND AMPERE RATING.
T	TELEPHONE/DATA OUTLET FLUSH MOUNTED 18" ABOVE FLOOR UNLESS OTHERWISE NOTED. PROVIDE 3/4" EC WITH PULL STRING TO 6" ABOVE ACCESSIBLE CEILING. COORDINATE EXACT LOCATION WITH ARCHITECT.
H	BRANCH CIRCUIT HOMERUN TO PANELBOARD, NUMBER OF ARROWS INDICATES NUMBER CIRCUITS IN RUN TO PANEL INDICATED. NUMBER OF SHORTER CROSSMARKS INDICATE NUMBER OF PHASE CONDUCTORS. LONGER CROSSMARK INDICATES NEUTRAL. EQUIPMENT GROUND WIRE IS SHOWN WITH DOT. UNLESS OTHERWISE NOTED, CONNECT CIRCUIT TO 20AMP SINGLE POLE BRANCH WITH DOT. UNLESS OTHERWISE NOTED, CONNECT CIRCUIT TO 20AMP SINGLE POLE BRANCH PROJECT SPECIFICATIONS.
	NEW WIRING
	LOW VOLTAGE WIRING
	120/240V, 1 PH PANEL. SURFACE OR RECESS MOUNTED
M	METER SOCKET
	SAFETY SWITCH (F.S.S FUSIBLE, N.F.S.SNON-FUSIBLE) 3P-30A/30 INDICATES # OF POLES-FRAME SIZE/FUSE SIZE
\$ _m	SINGLE OR DOUBLE POLE PROTECTION DEVICE
J	ELECTRICAL JUNCTION BOX.
Ø ∮ _{EF}	EXHAUST FAN MOTOR LOAD
Ó Ó _D	MOTOR OUTLET, "D" INDICATES MOTOR EQUIPPED WITH FACTORY INSTALLED DISCONNECTING MEANS
1	REFERENCED PLAN NOTE DESIGNATION
(1)	RISER DIAGRAM REFERENCE NOTE



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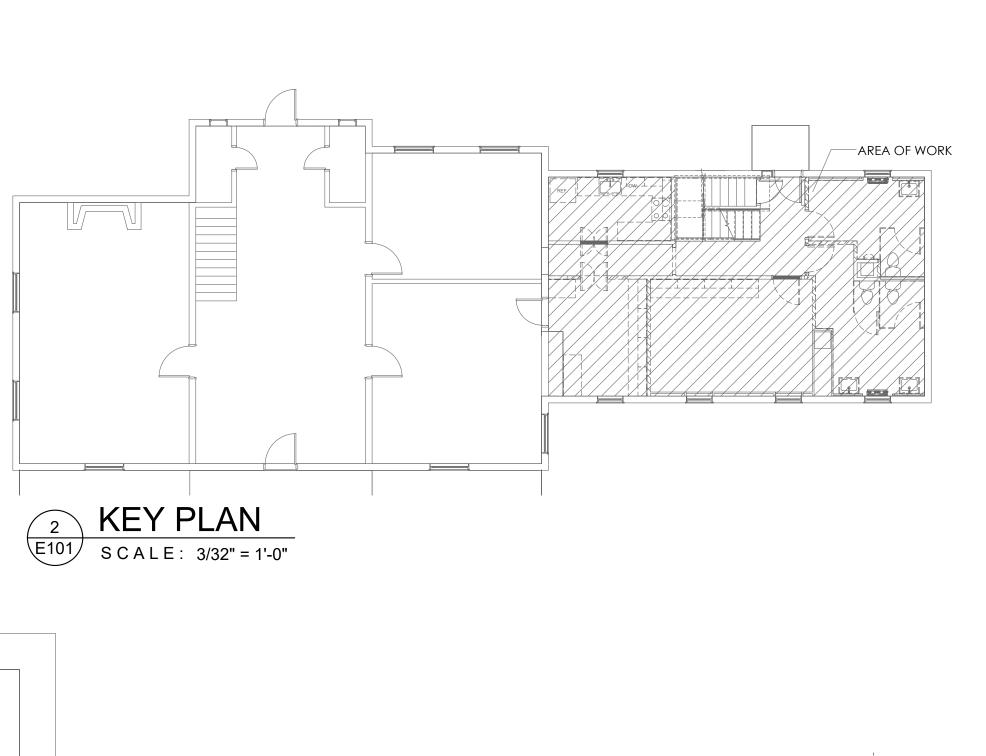
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02	06/18/25	CHECK SET				
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DRAWING TITLE: NOTES AND SYMBOLS - ELECTRICAL

DRAWING NUMBER: COMM. NO: DRAWN: CHECKED: SCALE: DATE:



LEGEND

(D) TO BE DEMOLISHED (E) EXISTING TO REMAIN

REFERENCED PLAN NOTES Applicable to this drawing only

1 REMOVE ALL LIGHTING FIXTURES AND CONTROLS IN THIS AREA. FIELD COORDINATE.

GENERAL PLAN NOTES Applicable to all drawings

CONTRACTOR SHALL FIELD TRACE ALL CIRCUITS PRIOR TO STARTING OF WORK. RE-WIRE AS SHOWN IF EXISTING CIRCUIT COULD BE RELOCATED OR IS DEMOLISHED. FIELD COORDINATE.



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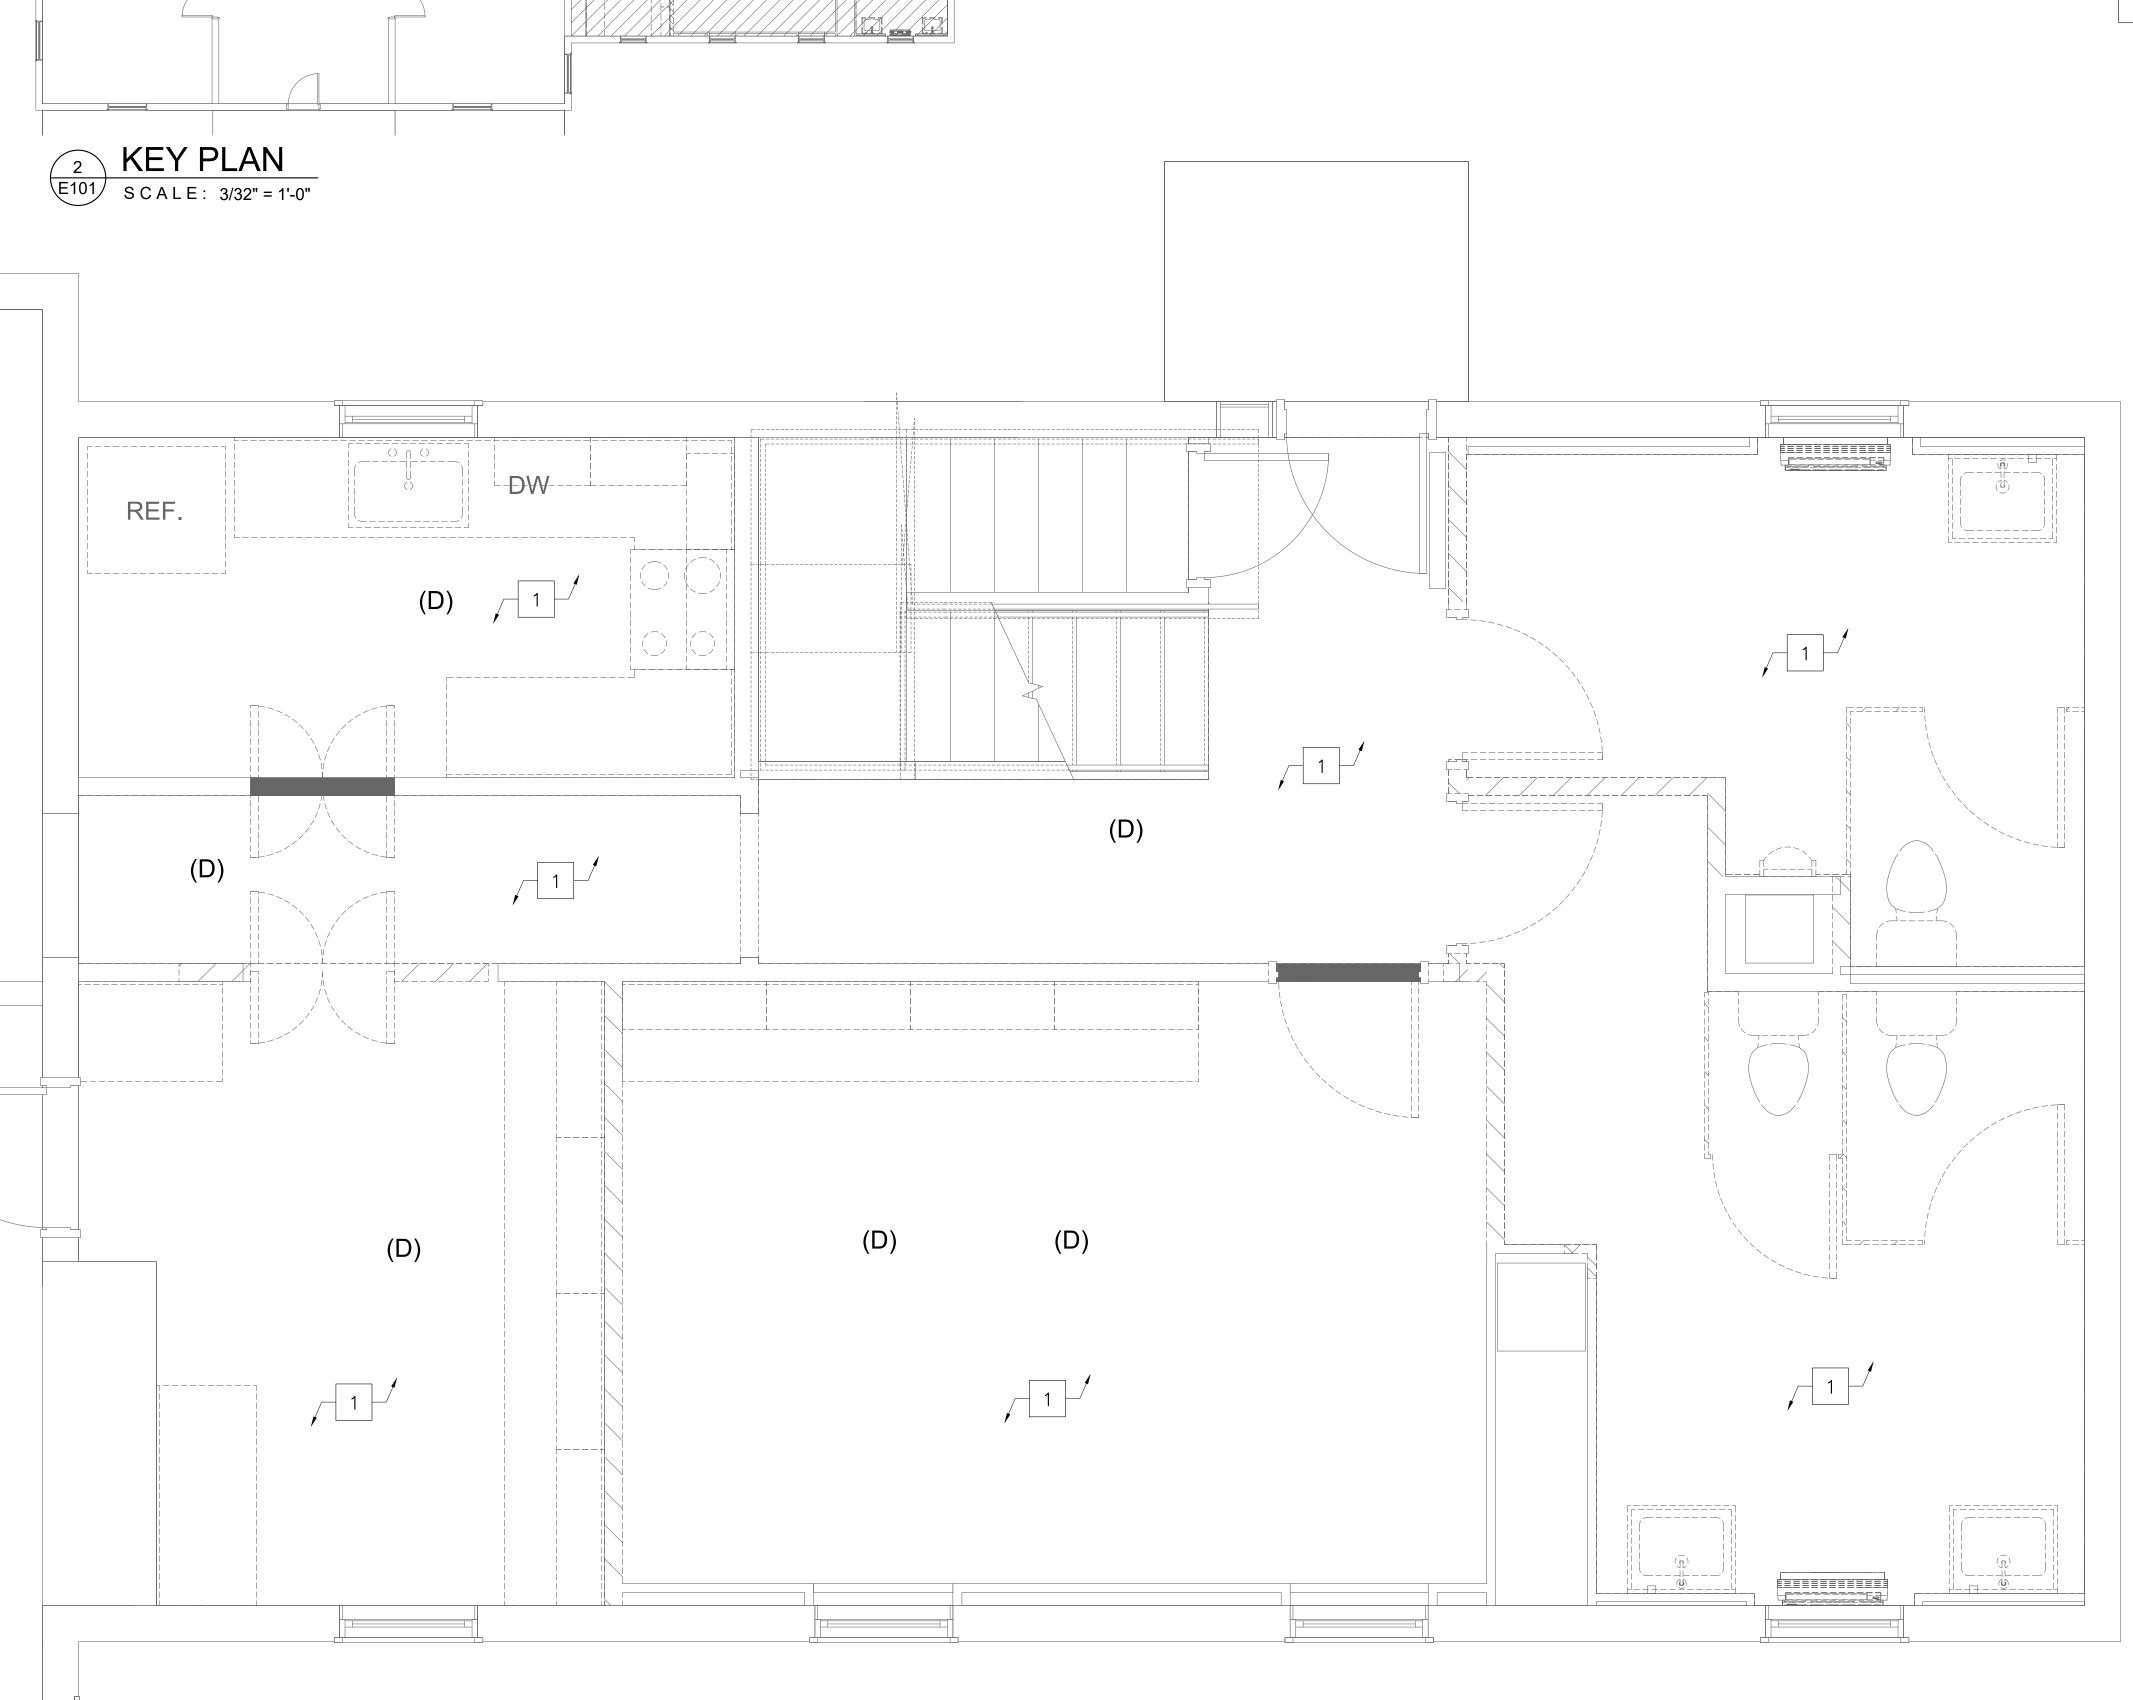
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DRAWING TITLE: DEMOLITION LIGHTING PLAN - ELECTRICAL

COMM. NO:	DRAWING NUMBER:
DRAWN:	-
CHECKED:	F101
SCALE:	
DATE:	-



DEMOLITION LIGHTING PLAN

E101 SCALE: 1/2" = 1'-0"

LEGEND

- (D) TO BE DEMOLISHED
- (E) EXISTING TO REMAIN
 (ER) EXISTING TO BE RELOCATED
 LC LOAD CENTER

REFERENCED PLAN NOTES Applicable to this drawing only

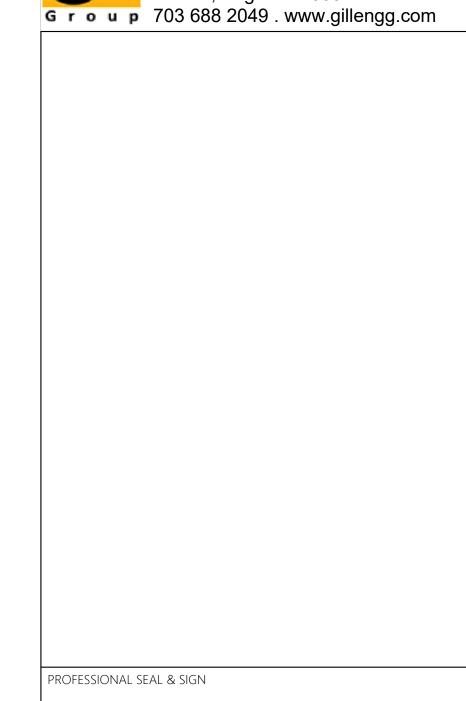
- 1 EXISTING TO REMAIN 200A, 120/240V, 1PH, 3W LOAD CENTER. REFER TO RISER DIAGRAM AND LOAD CENTER SCHEDULE FOR MORE INFORMATION.
- 2 REMOVE ALL POWER AND DATA OUTLETS IN THIS AREA. FIELD COORDINATE.
- EXISTING TO BE RELOCATED FAN COIL UNIT. PROVIDED SPLICE BOX AND EXTEND BRANCH CIRCUIT TO FCU NEW LOCATION.



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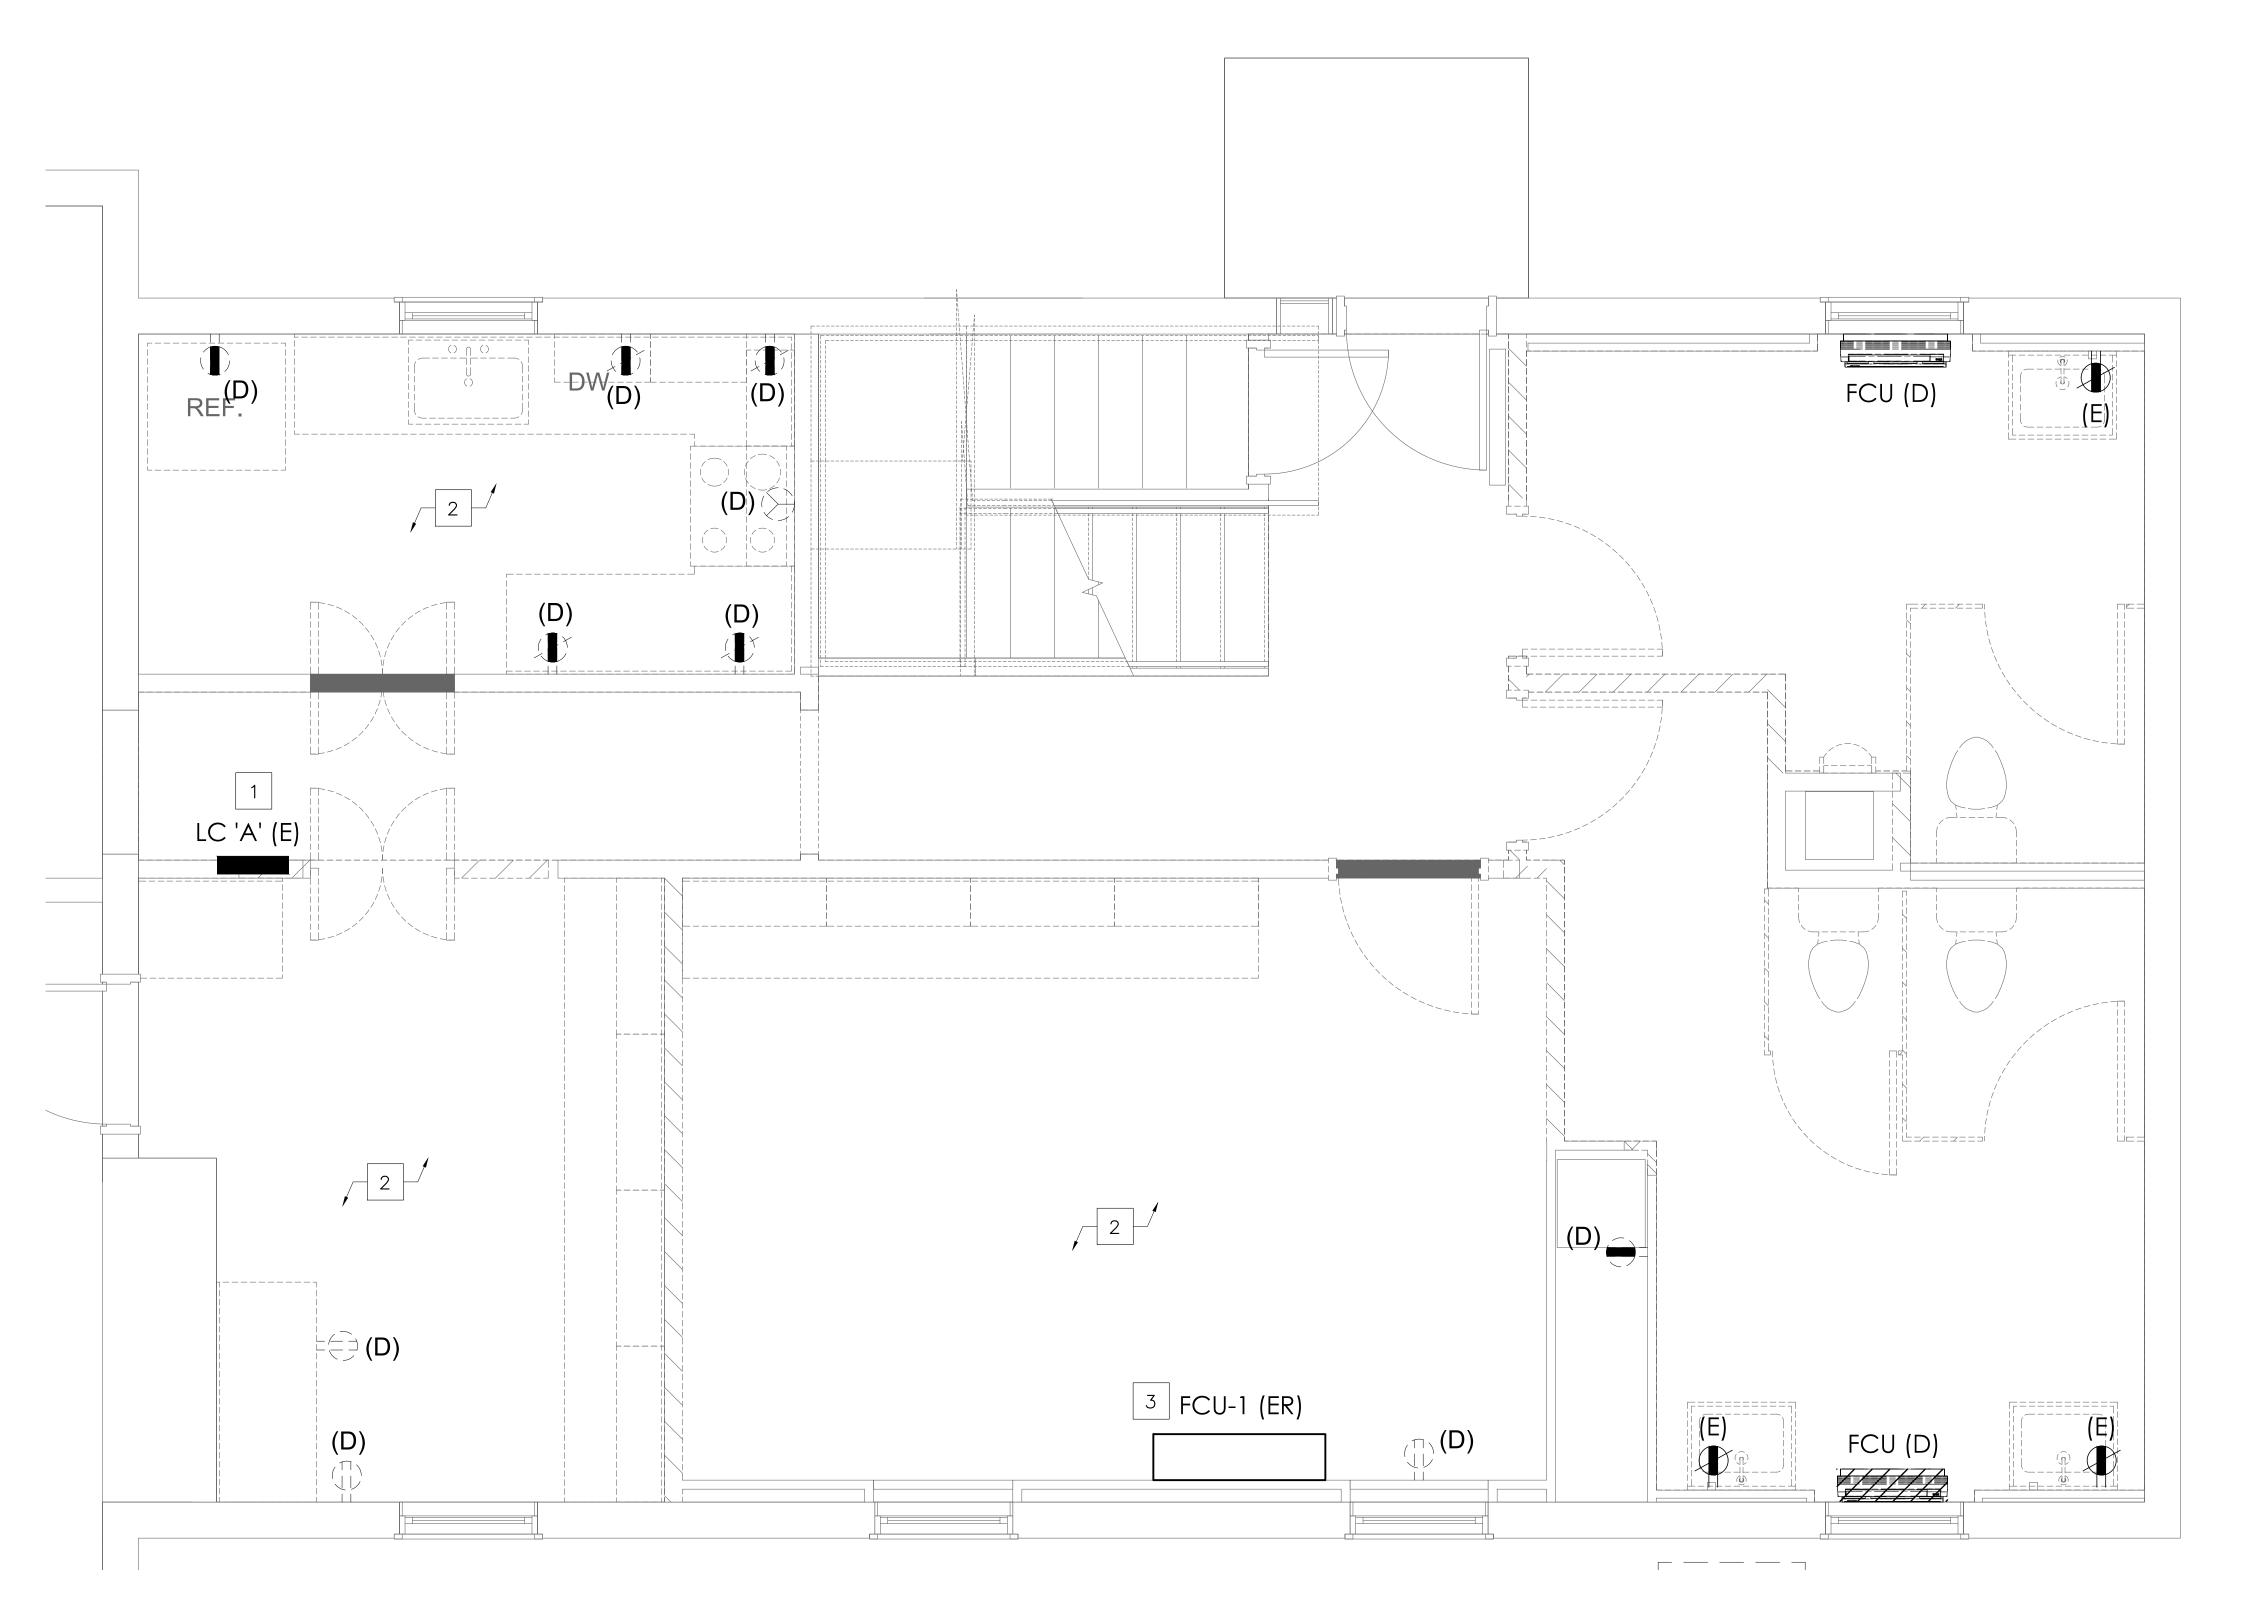
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DEMOLITION POWER PLAN
- ELECTRICAL

COMM. NO:	DRAWING NUMBER:
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CHECKED:	E102
SCALE:	
DATE:	



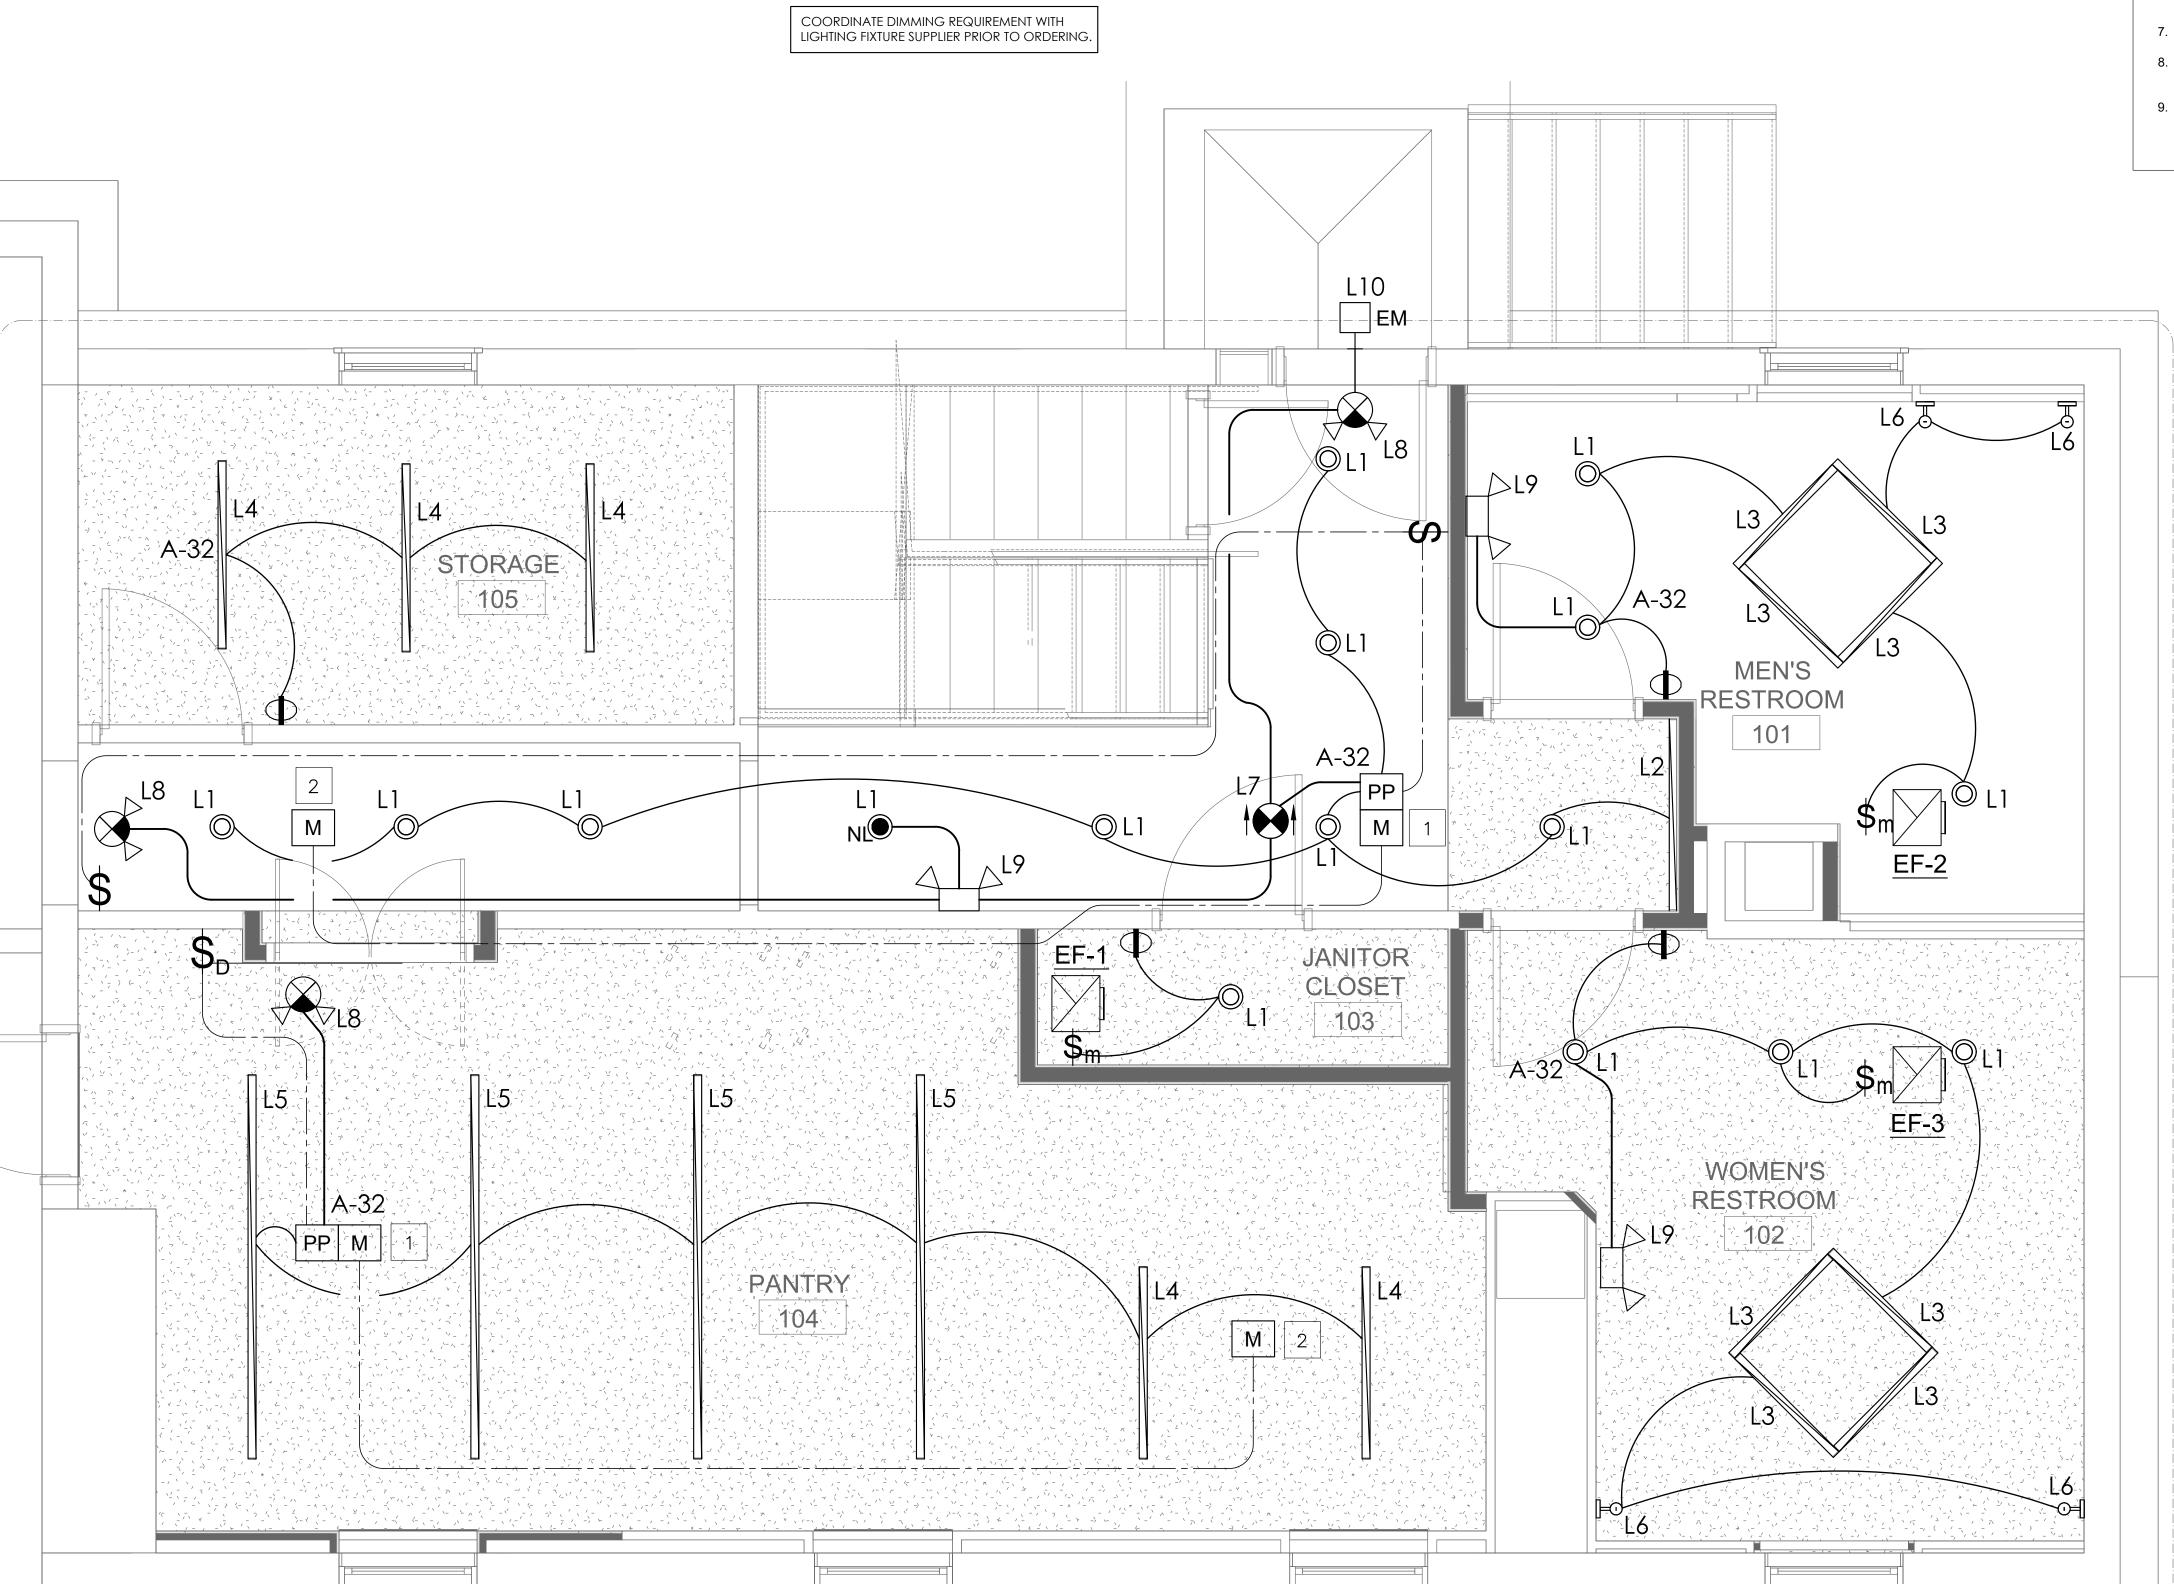


REFERENCED PLAN NOTES Applicable to this drawing only

- 1 CEILING MOUNTED MOTION SENSOR AND POWER PACK WATT STOPPER BZ-150 OR EQUAL. FIELD COORDINATE LOCATION.
- 2 CEILING MOUNTED MOTION SENSOR WIRED IN SLAVE CONFIGURATION.

GENERAL NOTES Applicable to all drawings

- 1. ALL TERMINATIONS OF CONDUCTORS 100A OR LESS SHALL COMPLY WITH NEC 110.14 (C) (1) (A)
- 2. ALL MCB CABLE SHALL BE INSTALLED ABOVE JOIST AREA TO PREVENT PHYSICAL DAMAGE TO THE CABLE. DO NOT INSTALL MC CABLE IN AREAS SUSCEPTIBLE TO PHYSICAL DAMAGE.
- 3. ALL LIGHTING FIXTURES ARE TO BE COORDINATED WITH LIGHTING DESIGNER. COORDINATE WIRING AND CONTROLS IF DIMMING IS REQUIRED.
- 4. EQUIPMENT FOR EMERGENCY EGRESS ILLUMINATION SHALL BE OPERATED AND INSTALLED IN ACCORDANCE WITH THE REQUIREMENTS OF NEC 700.12 (F).
- 5. ALL VACANCY SENSORS SHALL BE DUAL TECHNOLOGY.
- 6. ALL VACANCY SENSORS SHALL BE SET TO MANUAL-ON / AUTO-OFF WITHIN 20 MINUTES OF OCCUPANT LEAVING THE ROOM. MAXIMUM OVERRIDE SHALL BE 2 HOURS.
- 7. COORDINATE EXACT LOCATIONS AND MOUNTING HEIGHTS OF SWITCHES WITH OWNER.
- 8. REMOVE EXISTING LIGHT FIXTURES WHEN DIRECTED BY GENERAL CONTRACTOR. MAINTAIN EXISTING LIGHTING FOR CONSTRUCTION.
- 9. CONTRACTOR SHALL FIELD TRACE EXISTING TO REMAIN CIRCUITS PRIOR TO STARING OF WORK. RE-WIRE AS SHOWN IF EXISTING CIRCUIT COULD BE RELOCATED OR IS DEMOLISHED. FIELD COORDINATE.



1 NEW LIGHTING PLAN

E200 S C A L E: 1/2" = 1'-0"

MAGINNISS+ DEL NINNO ARCHITEC

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DRAWING TITLE:
NEW LIGHTING PLAN
- ELECTRICAL

COMM. NO:

DRAWN:

CHECKED:

SCALE:

DATE:

	EQUIPMENT SCHEDULE												
NO.	ITEM	KW	MCA	МОСР	VOLT	РН	HZ	PLUG NEMA					
K01	REFRIGERATOR	0.65	5.4	15	115	1	60	5-15P					
К02	FREEZER	0.44	3.7	15	115	1	60	5-15P					
К03	ICE MAKER	2.06	8.9	15	240	1	60	DIRECT					
К05	FOOD WARMER	1.50	12.5	15	120	1	60	5-15P					
К07	DISHWASHER	1.07	8.9	15	120	1	60	5-15P					
K10	CONVECTION MW	6.80	28	30	240	1	60	DIRECT					

REFERENCED PLAN NOTES Applicable to this drawing only

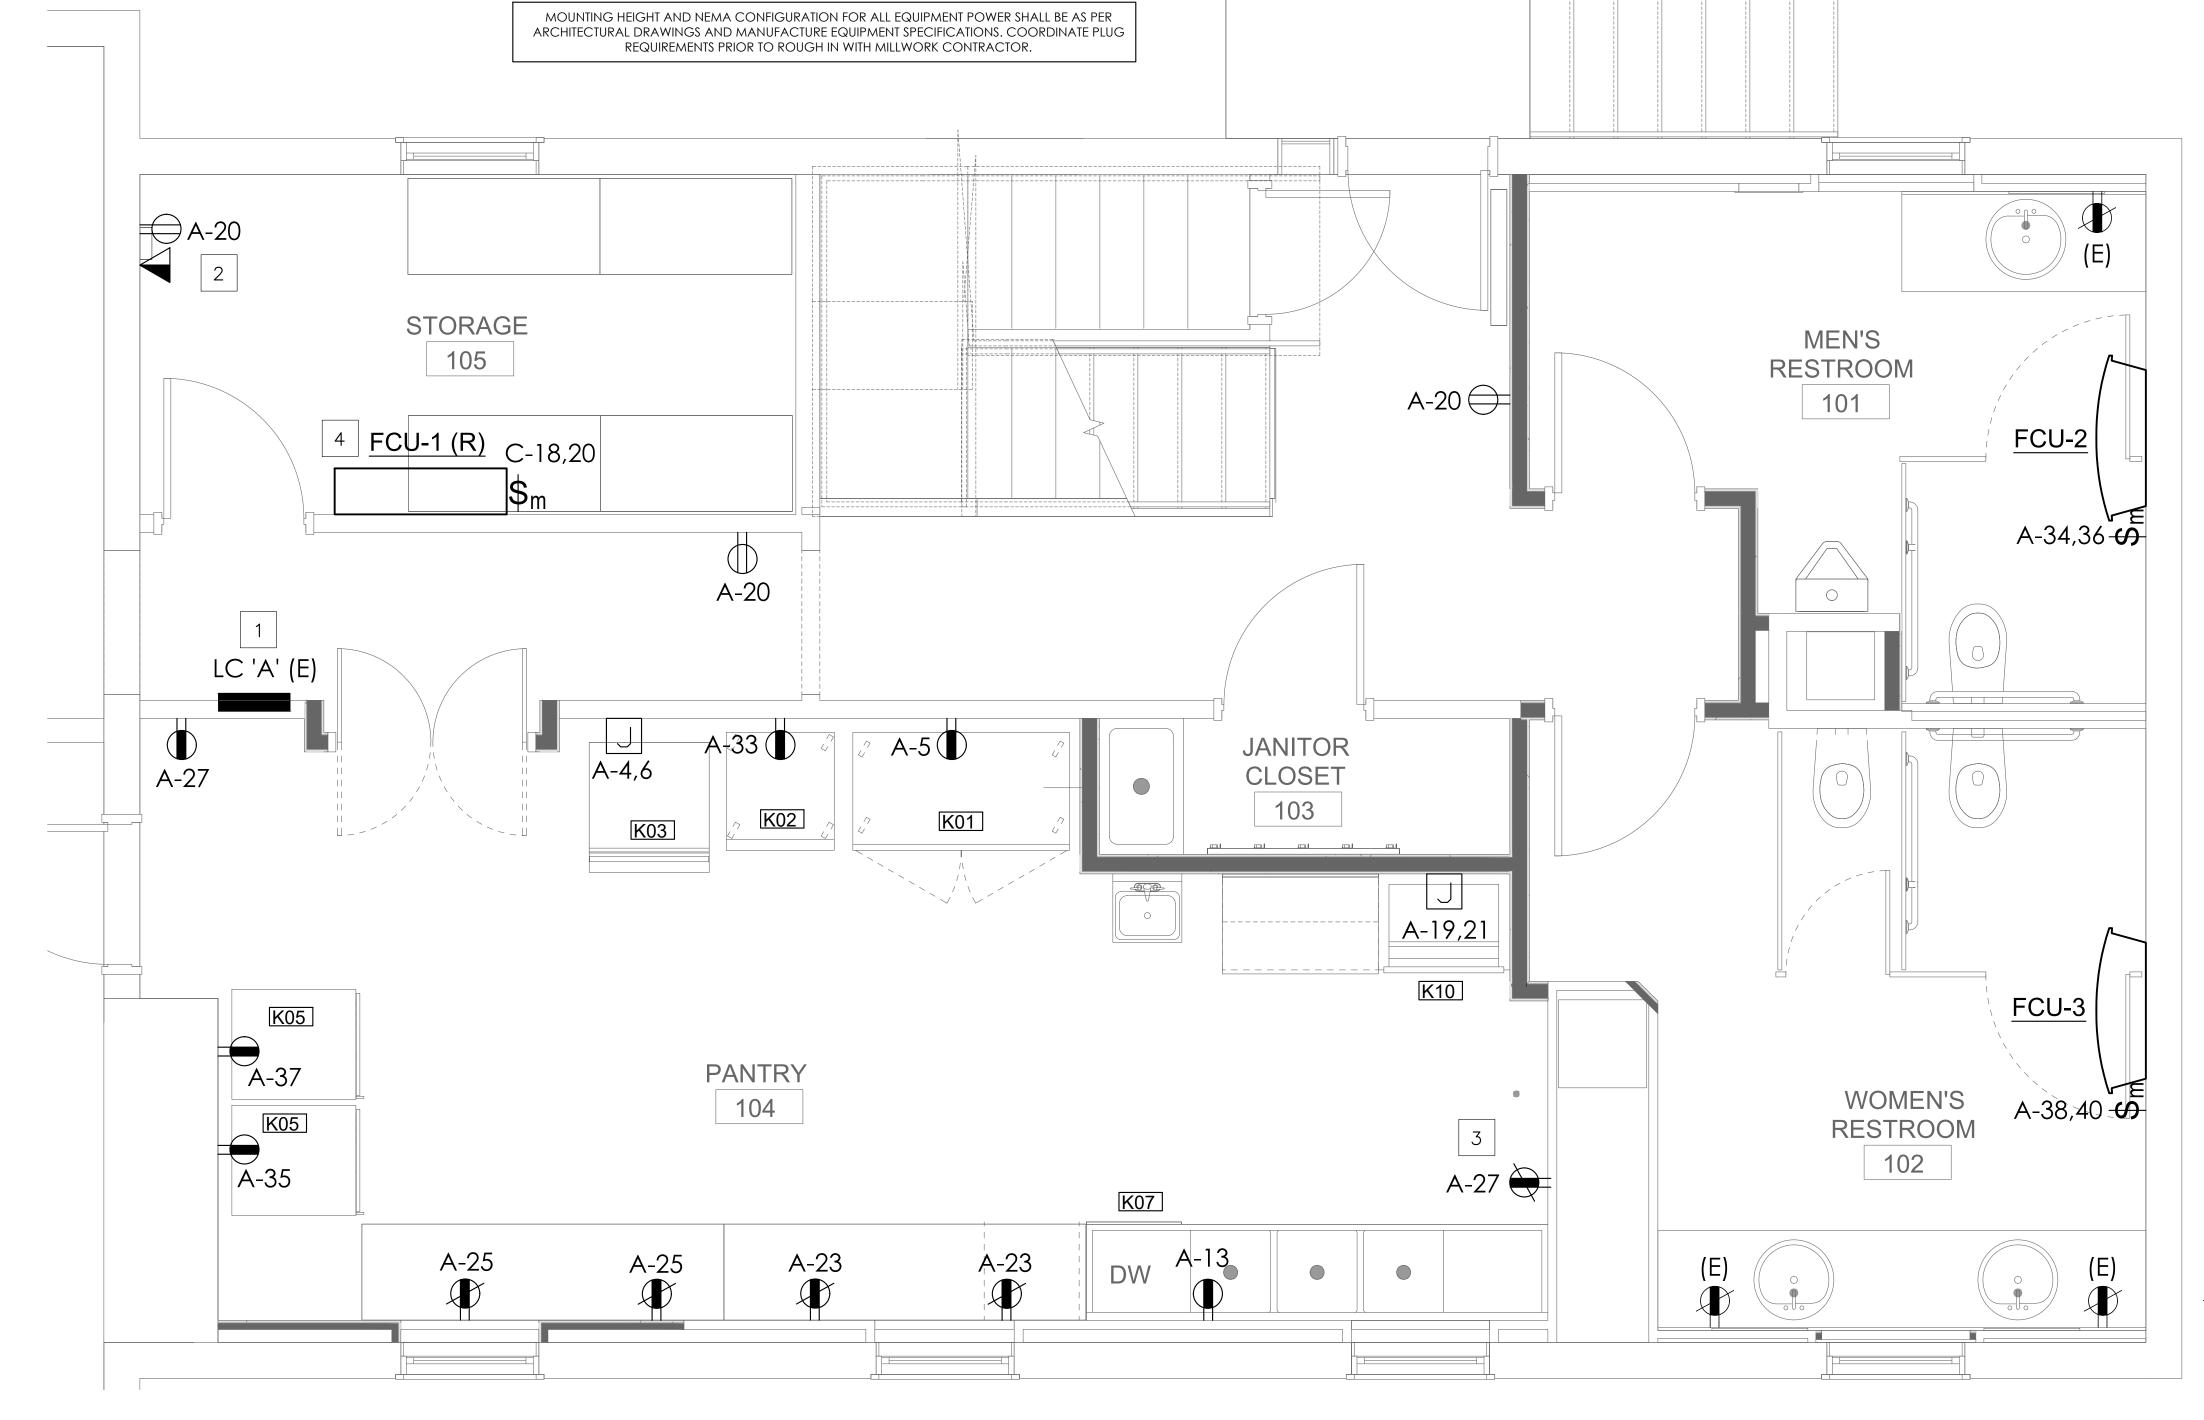
- EXISTING TO REMAIN 200A, 120/240V, 1PH, 3W LOAD CENTER. REFER TO RISER DIAGRAM AND LOAD CENTER SCHEDULE FOR MORE INFORMATION.
- FIELD COORDINATE MOUNTING HEIGHT.
- COORDINATE MOUNTING HEIGHT AND REQUIREMENTS OF OUTLET FOR WALL-MOUNTED FAN PRIOR TO INSTALLATION.
- RELOCATED FAN COIL UNIT. PROVIDE 2 POLE 15A DISCONNECT SWITCH. EXTEND EXISTING CIRCUIT TO FCU LOCATION. FIELD COORDINATE.

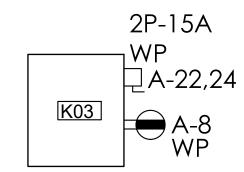
LEGEND

- (E) EXISTING TO REMAIN
- (R) RELOCATED
- LC LOAD CENTER


PANTRY EQUIPMENT GENERAL NOTES

- COORDINATE AND REFER TO ARCHITECTURAL DRAWINGS FOR EXACT LOCATIONS, REQUIREMENTS BEFORE INSTALLATION
- 2. THE CONTRACTOR SHALL MAKE ALL FINAL CONNECTIONS TO EQUIPMENT AFTER THE EQUIPMENT HAS BEEN SET IN PLACE. THIS CONTRACTOR SHALL SHORTEN CORDS, FURNISH AND INSTALL CORRECT RECEPTACLE OUTLETS/ PLUGS, CAPS, CORD SETS, JACKS...ETC AS REQUIRED FOR A COMPLETE AND FUNCTIONAL INSTALLATION OF EQUIPMENT.
- 3. ALL EQUIPMENT AND APPLIANCES SHALL BE GROUNDED IN ACCORDANCE WITH THE NATIONAL ELECTRICAL CODE (NEC) AND ALL APPLICABLE LOCAL CODES.
- 4. PROVIDE GROUND-FAULT INTERRUPTER (GFI) RECEPTACLES WHERE ARE INSTALLED TO SERVE THE COUNTERTOP SURFACES AND CONVENIENCE RECEPTACLES LOCATE IN PANTRY. CONTRACTOR SHALL PROVIDE GFI BREAKER IN PANEL IF RESET BUTTON IS NOT READILY ACCESSIBLE.
- 5. ALL REQUIRED FLEXIBLE CONNECTIONS TO EQUIPMENT SHALL HAVE LIQUID-TIGHT FLEXIBLE
- 6. COORDINATE WITH EQUIPMENT SUPPLIED VENDOR/ MANUFACTURER FOR EXACT NEMA CONFIGURATION AND DISCONNECT REQUIREMENTS.
- 7. COORDINATE WITH ICE MAKER SUPPLIED VENDOR/ MANUFACTURER FOR EXACT WIRING CONNECTION AND REQUIREMENTS.
- 8. ALL EXPOSED INTERIOR WIRING SHALL BE IN GALVANIZED STEEL CONDUIT OR ALUMINUM EMT WITH STEEL SET SCREW CONNECTORS.





ICE MAKER CU FIELD COORDINATE LOCATION

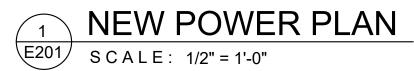

DRAWING NUMBER: COMM. NO: DRAWN: E201 CHECKED:

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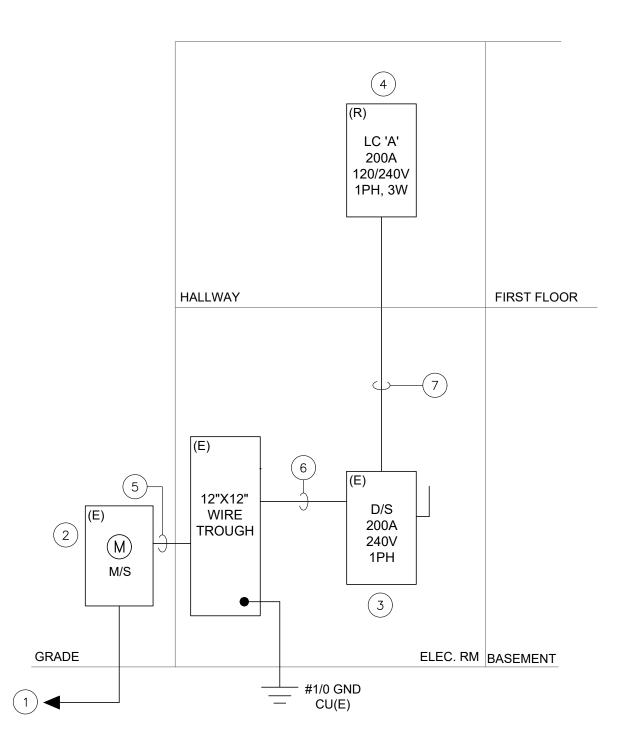
RUST MANOR

802 CHILDRENS CENTER RD LEESBURG, VA 20175

DRAWING TITLE: **NEW POWER PLAN** - ELECTRICAL

SCALE:

DATE:



EXISTING PARTIAL RISER DIAGRAM E202 SCALE: N.TS.

▶ COM*check* Software Version COMcheckWeb **Interior Lighting Compliance Certificate**

2021 IECC Energy Code: Project Title: Rust Manor Project Type: Alteration

Construction Site: Owner/Agent: Designer/Contractor: 802 Childrens Center Rd Leesburg, Virginia 20175

Allowed Interior Lighting Power

Area Category	Floor Area (ft2)	a Allowed Watts / ft2	Allowed Watts
1-Convention Center	933	0.64	597
		Total Allowed Watts =	597
Proposed Interior Lighting Power			

Proposed Interior Lighting Power

A Fixture ID : Description / Lamp / Wattage Per Lamp / Ballast	B Lamps/ Fixture		D Fixture Watt.	(C X D)
Convention Center (933 sq.ft.)				
LED: L1: Other:	1	15	11	165
LED: L2: Other:	1	1	12	12
LED: L3: Other:	1	8	9	72
LED: L4: Other:	1	5	12	60
LED: L5: Other:	1	4	12	48
LED: L6: Other:	1	4	12	48
	Tot	al Propose	ed Watts =	405

Interior Lighting Compliance

Statement Compliance Statement: The proposed interior lighting alteration project represented in this document is consistent with the building plans, specifications, and other calculations submitted with this permit application. The proposed interior lighting systems have been designed to meet the 2021 IECC requirements in COMcheck Version COMcheckWeb and to comply with any applicable mandatory requirements listed in the Inspection Checklist.

Name - Title Signature

Project Title: Rust Manor Report date: 07/09/25 Data filename: Page 1 of 5

LEGEND

- (E) EXISTING TO REMAIN
- M/S METER SOCKET
- D/S DISCONNECT SWITCH CU COPPER
- AL ALUMINUM

POWER RISER DIAGRAM NOTES

- 1 EXISTING TO REMAIN INCOMING POWER COMPANY FEEDERS.
- 2 EXISTING TO REMAIN 120/240V, 1PH, 3W POWER COMPANY METER SOCKET IN NEMA 3R.
- 3 EXISTING TO REMAIN 200A, 240V, 1PH SERVICE RATED DISCONNECT SWITCH FUSED AT 125A.
- EXISTING TO REMAIN 200A, 120/240V, 1PH, 3W LOAD CENTER. REFER TO LOAD CENTER SCHEDULE FOR MORE INFORMATION.
- 5 EXISTING TO REMAIN SERVICE FEEDERS.
- EXISTING TO REMAIN 3#1/0 AND 1#1/0 GND CU CONDUCTORS IN 2" CONDUIT. FIELD VERIFY.

26.55 111 T THRUTIME CLOCK

P THRUPHOTO CELL

L PROVIDE LOCKABLE BREAKER

7 EXISTING TO REMAIN 3#1/0 AND 1#2 GND AL SER CABLE. FIELD VERIFY.

EQUIPMENT WIRE SIZE TABLE (COPPER)											
AMPS	SERVICE	CONDUCTO	DR(S) SIZE	NETUI CONDUCTOR		GROUND CONDCTOR	CONDUIT SIZE (INCHES)				
	120V/1PH 277V/1PH	208V/1PH	208V/3PH 480V/3PH	YES	NO	SIZE (G)					
20	1#12	2#12	3#12	1#12		1#12	0.75				
30	1#10	2#10	3#10	1#10		1#10	0.75				
40	1#8	2#8	3#8	1#8		1#10	0.75				
55		2#6	3#6	1#6		1#10	1				
70		2#4	3#4	1#4		1#8	1.25				
85		2#3	3#3	1#3		1#8	1.25				
110		2#1	3#1	1#1		1#6	1.5				
150			3#1/0	1#1/0		1#6	2				
200			3#3/0	1#3/0		1#6	2.5				
400			3-600KCMIL	1-600 KCMIL		1#3	4				
NOTES:											

ALL WIRE SIZES ARE IN AWG OR KCMIL AS INDICATED

COPPER CONDUCTORS ONLY

PROVIDE NEUTRAL CONDUCTOR IF RECOMMENDED BY MANUFACTURER FOR 1 AND 3 PHASE MOTORS ALL CONDUCTORS INSTALLED ON ROOF SHALL BE COPPER XHHW-2 INSULATION.

					L	OAD	CE	NTE	R				
EXIST	TING LOAD C	ENTER FI	ED FRO	M 200	A DIS	CON	NECTS	WITC	H FUS	SED A	Г125А.		
	PANEL	VOLTAGE	120/240	PHASE	1	WIRES	3	MAINS) :	200 An	nps	MOUNTING: RECESSED	
	Α	A.I.C RATI	NG	EXISTIN	NG		REMA	RKS:	MLO				
ABBV.	BRANCH CIRCUIT LOAD DESCRIPTION		LOAD KVA	CIRCU			PHASE A/B	CIRCU No.		EAKER POLE	LOAD KVA	BRANCH CIRCUIT LOAD DESCRIPTION	ABBV.
EX	OFFICE/2ND FL	LR LTS	0.50	1	20	1	A	2	20	1	0.30	2ND FLOOR BATH LTS & REC.	EX
EX	WALL LTS	-11 -10	0.10	1	20	3	В	4	15	2	1.03	PANTRY 104 ICE. K03	N,L
EX	PANTRY 104 R	EF. KO1	0.65	1	20	5	Α	6			1.03		,
EX	2ND FLOOR BE		0.20	1		7	В	8	20	1	0.80	BATH LTS & REC. #2, BRIDES	EX
EX	BASE & STAIR	LTS, LIB RE	0.20	1	20	9	Α	10	20	1	0.20	HALLWAY, LTS #2	ΕX
EX	SPARE			1	20	11	В	12	20	1	0.20	HALLWAY, LTS #3	ΕX
EX	PANTRY 104 D	W K07	1.07	1	20	13	Α	14	20	1	0.10	MEETING RM LTS	EX
EX	BOILER		1.00	1	20	15	В	16	20	1	0.80	MEETING RM REC.	EX
EX	SPARE			1	20	17	Α	18	20	1		SPARE	EX
N,L	PANTRY 104 N	/W K10	3.40	2	30	19	В	20	20	1	0.60	HALLWAY/STO. 105 REC.	EX
			3.40			21	Α	22	15	2	0.12	ICE MAKER CU	N
EX	PANTRY 104 R	REC.	0.40	1	20	23	В	24			0.12		
EX	PANTRY 104 R	REC.	0.40	1	20	25	Α	26	20	1		SPARE	EX
EX	PANTRY 104 R	REC.	0.40	1	20	27	В	28	20	1	0.60	DINNING RM REC.	EX
EX	DINNING RM L		0.10	1	20	29	Α	30	20	1		SPARE	EX
EX	FOYER LTG & F		0.40	1	15	31	В	32	20	1	0.68	RM 101-105 LTS	EX
EX	PANTRY 104 F		0.44	1	15	33	A	34	15	2	0.91	FCU-2	N
EX	PANTRY 104 V		1.50	1	15	35	В	36	<u> </u>		0.91		
EX	PANTRY 104 V	VARM K05	1.50	1	15	37	A	38	15	2	0.91	FCU-2	N
	BUS SPACE				20	39	B	40			0.91	A DDDD // ATIONS	
ITEM		DEAIV	IAND LO	JAD C		CTOR	JN 	Κ\	/^	AMPS	A	ABBREVIATIONS ARC FAULT BREAKER	
LIGHTI	ING			Χ		1.25	=	3.3		AIVIPS	A.I.C.	AMPS INTTERUPT RATING	<u>. </u>
HVAC				X		1.00	=	3.6			EX	EXISTING TO REMAIN	•
EQUIP	MENT			X		1.00	=	15.			G	GROUND FAULT INTERUP	т
KITCHI	EN			X).65	=	0.0			Н	TYPHACR	
RECEP	TACLES- FIRST	10.0 KVA A	T 100%	Χ	1	1.00	=	4.3	30		N	NEW	
RECEP	TACLES- REMA	NINGAT5	50%	Х	(0.50	=	0.0	00		R	REMOVE	
SUB PA	ANEL			Х	1	1.00	=	0.0	00		S	SHUTTRIP DEVICE	
					I		1					TIDLITAE OLOOK	

NOTES ELECTRICAL CONTRACTOR TO FILED TRACE ALL EXISTING CIRCUITS PRIOR TO STARTING OF WORK.

LIGHTING FIXTURE SCHEDULE												
FIXTURE DESIGNATION	FIXTURE TYP	NUMBER OF LAMPS	WATTS EACH	TYPE OF LAMP	FIXTURE WATTAGE	VOLTAGE 120 V/1PH	MODEL NUMBER	REMARKS/OPTIONS	MANUFACTURER			
L1	6" ROUND CANLESS LED DOWNLIGHT	1	11	LED	11	120V	HLB6099FSE010MWR	DIMMABLE	COOPER LIGHTING			
L2	4' LED RECESSED PERIMETER	1	12	LED	12	120V	S122DRP-S-290D-8-40-4F0-1-U-DD-W	DIMMABLE	COOPER LIGHTING			
L3	3' LED RECESSED DIRECT	1	9	LED	9	120V	S122DR-S-290D-40-3F0-1-U-DD-W	DIMMABLE	COOPER LIGHTING			
L4	4' LED RECESSED DIRECT	1	12	LED	12	120V	S122DR-S-290D-40-4F0-1-U-DD-W	DIMMABLE	COOPER LIGHTING			
L5	8' LED RECESSED DIRECT	1	12	LED	12	120V	S122DR-S-290D-40-4F0-1-U-DD-W	DIMMABLE	COOPER LIGHTING			
L6	VANITY LIGHT	1	12	LED	12	120V	TBD		TBD			
L7	EXIT SIGN	1	0.05	LED	0.05	120V	LQM-S-W-3-R-MVOLT-ELN-SD	SD:SELF-DIAGNOSTICS TEST	LITHONIA LIGHTING			
L8	COMBO EXIT SIGN	2		LED	4.3	120V	LQHM-LED-R-SD	SD:SELF-DIAGNOSTICS TEST	LITHONIA LIGHTING			
L9	INDOOR EM LIGHT	2	-	LED	0.06	120V	EU2C-SD	SD:SELF-DIAGNOSTICS TEST	LITHONIA LIGHTING			
L10	OUTDOOR EM LIGHT	1	-	LED	24	120V	CAM-ACSD-CW-P	W/ INTEGRAL PHOTOCELL	LIGHT ALARMS			

1. COLOR OR ALL LAMPS SHALL BE THE SAME (4000K), UNLESS OTHERWISE DIRECTED.

2. HEIGHT ABOVE FINISHED GRADE OF WALL MOUNTED EXTERIOR FIXTURES SHALL BE DETERMINED BY ARCHITECT.

3. ALL EXIT LIGHTS SHALL BE SINGLE-FACE AND/OR DOUBLE-FACE AS INDICATED ON PLANS. FIXTURE SHALL BE EQUIPPED WITH EMERGENCY BATTERY BACK-UP AND SELF-DIAGNOSTICS.

4. ALL EMERGENCY FIXTURES SHALL BE PROVIDED WITH EXTRA CONDUCTOR AND CONNECTED AHEAD OF ANY LOCAL SWITCH.

5. EMERGENCY LIGHTING FIXTURE TO BE PROVIDED WITH FULL OUTPUT BATTERY LASTING MINIMUM OF 90 MINUTES.

6. ALL EXTERIOR LIGHT FIXTURES SHALL BE SUITABLE FOR WET LOCATION INSTALLATION WITH BALLAST SUITABLE FOR COLD AND WET LOCATION.

7. ALL FIXTURES SHALL BE APPROVED BY TENANT AND ARCHITECT PRIOR TO PLACING ORDER. SUMBIT SHOP DRAWINGS FOR APPROVAL.

8. PROVIDE APPROPRIATE MOUNTING KIT.

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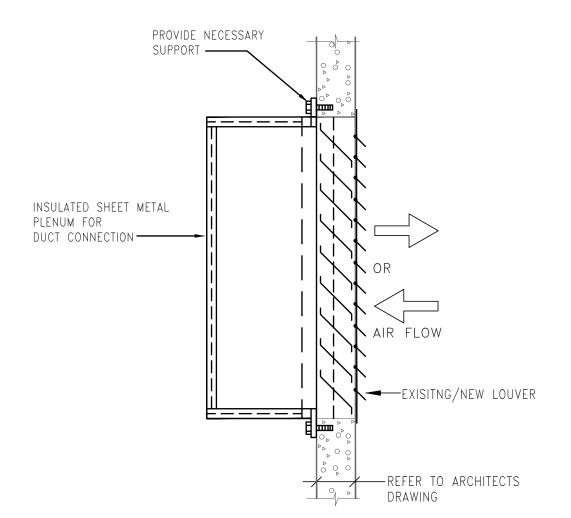
01	06/13/25	PROGRESS SET						
02	06/18/25	CHECK SET						
03	07/11/25	PERMIT SET						
ISSUE								

RUST MANOR


802 CHILDRENS CENTER RD LEESBURG, VA 20175

DRAWING TITLE: RISER DIAGRAM AND SCHEDULES - ELECTRICAL

COMM. NO:	DRAWING NUMBER:
DRAWN:	-
CHECKED:	E202
SCALE:	





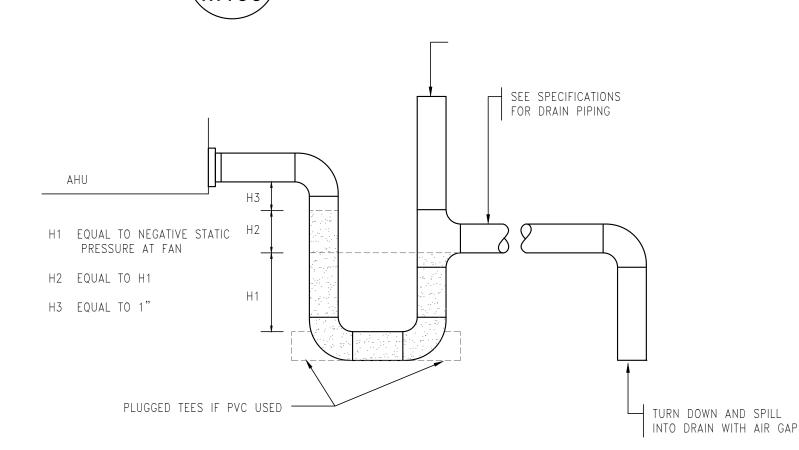

\CONDENSATE DRAIN DETAIL M100 Scale:N.T.S.

MECHANICAL GENERAL NOTES AND SPECIFICATIONS

- PROVIDE COMPLETE AND PROPERLY FUNCTIONING HVAC SYSTEMS FOR THIS PROJECT. VISIT THE PROJECT SITE, EXAMINE THESE PLANS AND ALL DRAWINGS RELATING TO THE AREA OF WORK, AND REPORT ANY DISCREPANCIES OR OMISSIONS IN THIS PLAN SET TO THE ENGINEER FOR RESOLUTION AND CLARIFICATION PRIOR TO SUBMISSION OF BIDS. BY SUBMITTING A BID ON THIS PROJECT, THE CONTRACTOR ACCEPTS THESE DOCUMENTS AS AN ADEQUATE DEFINITION OF THE SCOPE OF WORK. CLAIMS FOR ADDITIONAL COSTS TO ACHIEVE THE INTENDED SCOPE OF WORK WILL NOT BE ACCEPTED.
- ALL WORK SHOWN ON THESE DOCUMENTS IS NEW UNLESS SPECIFICALLY IDENTIFIED AS EXISTING OR PROVIDED BY OTHERS.
- INSTALL ALL WORK ON THIS PROJECT IN ACCORDANCE WITH THE 2021 VIRGINIA MECHANICAL CODE, 2021 VIRGINIA ENERGY CODE ALONG WITH ALL REFERENCED CODES AND REGULATIONS.
- OBTAIN AND PAY FOR ALL PERMITS ASSOCIATED WITH THIS PROJECT AND ARRANGE ALL REQUIRED INSPECTIONS BY THE APPROPRIATE LOCAL AUTHORITIES.
- THE CONTRACTOR MUST NOTIFY THE BUILDING OWNER IMMEDIATELY OF ANY DAMAGE OR THE DISCOVERY OF ANY EXISTING DAMAGE. THE PROTECTION OF ALL DRAINS IS REQUIRED TO PREVENT CLOGGING AND THE CONTRACTOR IS RESPONSIBLE FOR THE CLEANING OF ALL DRAINS WHICH HAVE BECOME CLOGGED DURING CONSTRUCTION.
- HVAC UNITS WITHIN THE CONSTRUCTION AREA SHALL BE PROTECTED TO PREVENT DUST, DEBRIS OR ODORS FROM ENTERING. SEAL ALL DUCT AND EQUIPMENT OPENINGS WITH PLASTIC. PROVIDE NEW FILTERS FOR ALL HVAC EQUIPMENT PRIOR TO COMPLETION OF PROJECT.
- THOROUGHLY CLEAN THE WORK AREA DAILY OR AS DIRECTED BY THE GENERAL CONTRACTOR OR OWNER. REMOVE ALL TRASH AND DEBRIS FROM THE PROJECT REMOVED FROM THE WORK AREA WHICH IS NOT REUSED BY THE OWNER UNLESS DIRECTED OTHERWISE BY THE OWNER'S REPRESENTATIVE.
- A PRELIMINARY INSPECTION OF THE HVAC WORK IN PROGRESS SHALL BE SCHEDULED THROUGH THE BUILDING OWNER PRIOR TO THE INSTALLATION OR RE-INSTALLATION OF THE CEILING GRID.
- SYMBOLS SHOWN ON SCHEDULES INDICATE THE TYPE OF EQUIPMENT ONLY. REVIEW DRAWINGS TO DETERMINE THE EXACT QUANTITIES REQUIRED FOR EACH EQUIPMENT TYPE.
- 10. THESE DRAWINGS ARE DIAGRAMMATIC AND ARE INTENDED TO DEPICT THE GENERAL LOCATION OF HVAC SYSTEM COMPONENTS. DO NOT SCALE MECHANICAL DRAWINGS. VISIT SITE FOR PROPER DIMENSIONS AND LOCATION OF EQUIPMENT.
- 11. PROVIDE ALL SUPPORT STEEL, HANGERS, VIBRATION ISOLATION AND ACCESSORIES REQUIRED TO INSTALL EQUIPMENT IN ACCORDANCE WITH THE MANUFACTURER'S RECOMMENDATIONS. DO NOT SUPPORT CEILINGS, LIGHTING FIXTURES, OR ANY OTHER DEVICES FROM DUCTWORK OR PIPING. UNLESS OTHERWISE NOTED. DO NOT ALLOW DUCTS, PIPES, OR CONDUITS TO DIRECTLY CONTACT THE BUILDING STRUCTURE.
- CONNECT ALL MECHANICAL EQUIPMENT TO DUCTWORK USING RUBBERIZED-CANVAS FLEXIBLE CONNECTIONS. INSTALL ALL MECHANICAL EQUIPMENT WITH VIBRATION ISOLATION DEVICES.
- ANY EQUIPMENT WHICH WILL REQUIRE PERIODIC INSPECTION OR SERVICE, IF LOCATED ABOVE OR BEHIND INACCESSIBLE CONSTRUCTION. SHALL BE PROVIDED WITH AN ACCESS DOOR OF SUFFICIENT SIZE TO PERMIT THE REQUIRED SERVICE. COORDINATE ACCESS PANEL LOCATIONS WITH ASSOCIATED EQUIPMENT LOCATIONS.
- 14. ALL EQUIPMENT SHALL BE INSTALLED PER MANUFACTURER'S INSTRUCTIONS AND/OR RECOMMENDATIONS.
- 15. PROVIDE EQUIPMENT SUITABLE FOR THE INTENDED PURPOSE. ALL MANUFACTURERS SHALL HAVE HAD SIMILAR PRODUCTS IN SATISFACTORY SERVICE FOR A MINIMUM OF 3 YEARS.
- 16. UNOBSTRUCTED ACCESS IS REQUIRED ON ALL SIDES OF ELECTRIC EQUIPMENT. LOCATE ALL SUCH EQUIPMENT WITH ADEQUATE CLEARANCE FOR MAINTENANCE AND TO MEET THE NATIONAL ELECTRICAL CODE'S REQUIRED CLEARANCES.
- 17. PROVIDE ALL NEW EQUIPMENT/MATERIALS WITH A WARRANTY FOR A MINIMUM OF ONE YEAR FROM THE DATE OF LANDLORD/OWNER ACCEPTANCE.

DUCTWORK:

18. FABRICATE DUCTWORK FROM GALVANIZED SHEET STEEL WITH G60 COATING IN ACCORDANCE WITH SMACNA DUCT CONSTRUCTION STANDARDS AND THE PRESSURE CLASSES SPECIFIED BELOW:

PRESSURE CLASS ("W.G.") /SEAL CLASS CONSTANT VOLUME EXHAUST AIR DUCT

2.0 / A

- 19. SEAL AND/OR REPAIR ANY DUCTWORK WITH VISUAL OR AUDIBLE SIGNS OF AIR LEAKAGE.
- 20. DUCTWORK SIZES SHOWN ARE INSIDE CLEAR DIMENSIONS.
- 21. USE THERMAFLEX G-KM (U.L. 181 CLASS 1) FACTORY-INSULATED TWO PLY BONDED ALUMINUM FLEXIBLE DUCTWORK. THE INSULATION SHALL INCLUDE A VAPOR BARRIER JACKET. LIMIT FLEXIBLE DUCT TO A MAXIMUM LENGTH OF 8 FEET.
 - SIZE FLEXIBLE DUCTWORK TO MATCH THE NECK SIZE OF THE DEVICE IT SUPPLIES UNLESS OTHERWISE SCHEDULED.
 - USE RIGID SPIRAL DUCT TO MAINTAIN FLEXIBLE DUCT LENGTHS UNDER 14 FEET (ROUND DUCT SIZE SHALL MATCH FLEXIBLE DUCT SIZE).

- c. CONNECT FLEXIBLE, OR RIGID ROUND DUCTWORK, TO THE LOW PRESSURE DUCT USING CLEVAFLEX TYPE DESC SPIN-IN COLLARS OR "AIR-TITE" ADHESIVE BACKED FITTINGS SECURED TO THE MAIN DUCT WITH SHEET METAL SCREWS. AT CONNECTIONS TO AIR DEVICES OR RIGID DUCT WORK, MECHANICALLY FASTEN AND SEAL FLEXIBLE DUCT AIRTIGHT.
- SEAL INSULATION JACKET USING INSULATION TAPE OR CEMENT TO MAINTAIN THE VAPOR BARRIER.
- e. DO NOT ROUTE FLEXIBLE DUCT THROUGH SLAB TO SLAB PARTITIONS. PROVIDE ROUND RIGID DUCT WHERE FLEXIBLE DUCTS ARE SHOWN TO PASS THROUGH SLAB TO SLAB PARTITIONS.
- PROVIDE TRANSITIONS AND ACCESSORIES TO CONNECT FLEXIBLE DUCT TO RIGID DUCT.
- INSTALL DUCTWORK TIGHT TO THE UNDERSIDE OF THE BUILDING STRUCTURE. ADJUST THE DUCT ELEVATION TO MAINTAIN DUCT TIGHT TO BOTTOM OF STRUCTURE WHERE STRUCTURE ELEVATIONS CHANGE.
- PROVIDE ALL NECESSARY TRANSITIONS IN DUCTWORK FOR CONNECTION TO EQUIPMENT AND ACCESSORIES. REDUCE DUCTWORK SIZES ONLY AT THE CONNECTION POINT TO EQUIPMENT.
- SUSPEND DUCTWORK FROM THE BUILDING STRUCTURE IN ACCORDANCE WITH THE SMACNA DUCT CONSTRUCTION STANDARDS. SECURELY ATTACH DUCTWORK SUPPORTS TO THE BUILDING STRUCTURE.
- 25. COORDINATE THE INSTALLATION OF THE DUCTWORK SYSTEM WITH THE BUILDING STRUCTURE AND THE WORK OF ALL OTHER CONTRACTORS. ADJUST DUCTWORK SIZES, LOCATION AND CONFIGURATION, INCLUDING DIFFUSER PLENUMS, AS REQUIRED TO COORDINATE WITH WORK OF THIS AND ALL OTHER TRADES. WHERE NECESSARY TO AVOID OBSTRUCTIONS, RE-SIZE, OFFSET, RAISE, OR LOWER THE DUCTWORK. DO NOT EXCEED THE DESIGN VELOCITIES IN ANY DUCT SECTIONS REQUIRING SIZING REVISIONS. INDICATE ALL COORDINATION ISSUES ON THE SHOP DRAWINGS.
- 26. PROVIDE TURNING VANES IN ALL 90° RECTANGULAR ELBOWS AND SPLITTER VANES IN ALL 90° RECTANGULAR RADIUS ELBOWS.
- 27. ELBOWS CONSTRUCTED USING A SHARP 90° ANGLE ON THE INSIDE OF THE ELBOW AND A RADIUS BEND ON THE OUTSIDE OF THE ELBOW (HARD RADIUS HEEL OR "SLED-BOOT" FITTING) WILL NOT BE ACCEPTED.
- INSTALL VOLUME DAMPERS IN ALL BRANCH DUCTWORK CONNECTIONS AT TAKE-OFF FROM MAIN TRUNK DUCT LEADING TO DIFFUSERS.
- PROVIDE THE AIR DISTRIBUTION DEVICES WITH APPROPRIATE FRAMES FOR INSTALLATION IN THE SELECTED CEILING CONSTRUCTION. COORDINATE COLOR SELECTION WITH THE ARCHITECT AND MAINTAIN A NC LEVEL OF 30 OR LESS IN ALL AIR DISTRIBUTION DEVICE SELECTIONS.
- 30. INSULATE ALL SUPPLY AND RETURN AIR DUCTS WITH MINIMUM R-6 INSULATION WITH INTEGRAL VAPOR BARRIER WRAP.
- 31. INSTALL ALL INSULATION IN ACCORDANCE WITH ASTM E84. PROVIDE INSULATION WITH A FLAME SPREAD RATING OF LESS THAN 25 AND A SMOKE DEVELOPED RATING OF LESS THAN 50 WHEN TESTED IN ACCORDANCE WITH ASTM E84.
- MAINTAIN VAPOR BARRIER ON ALL INSULATION APPLIED TO ALL EQUIPMENT, PIPING, OR DUCTWORK WHICH CONVEYS LIQUID OR AIR AT A TEMPERATURE OF LESS THAN
- 35. INSULATE ALL CONDENSATE PIPING WITH 0.5" THICK CLOSED-CELL ELASTOMERIC PIPE INSULATION

AIR SYSTEM BALANCING

- INCLUDE THE SERVICES OF A CERTIFIED INDEPENDENT BALANCING CONTRACTOR IN THE SCOPE OF THIS CONTRACT TO PERFORM ALL SYSTEM BALANCING PROCEDURES IN ACCORDANCE WITH NEBB AND AABC REQUIREMENTS.
- 37. PROVIDE ALL NECESSARY ACCESSORIES FOR DUCTWORK TO ALLOW PROPER AIR BALANCING. BALANCE AIR SYSTEMS TO QUANTITIES INDICATED ON THE PLANS UNDER THE SUPERVISION OF A REGISTERED ENGINEER. SUBMIT BALANCING REPORTS ON NEBB OR AABC FORMS APPROVED AND STAMPED BY THE REGISTERED ENGINEER WHO SUPERVISED THE TESTING.
- PERFORM A PRELIMINARY AIR SYSTEM BALANCE ON ALL DEVICES IN AREAS WHERE FINAL CLOSE-IN WOULD MAKE BALANCING MECHANISMS INACCESSIBLE. PRELIMINARY AIR BALANCING IS REQUIRED TO PREVENT THE GENERATION OF OBJECTIONABLE NOISE AT THE AIR DEVICES. SCHEDULE THE WORK SUCH THAT THE FAN SYSTEMS ARE FULLY OPERATIONAL FOR THE PRELIMINARY AIR BALANCE PRIOR TO APPLICATION OF THE FINAL FINISHES. PERFORM THE FINAL BALANCING AT THE AIR DEVICE WITH AN INTEGRAL OPPOSED BLADE DAMPER OR OTHER APPROVED BALANCING MECHANISM. ELIMINATE ANY OBJECTIONABLE NOISE CREATED BY THE BALANCING MECHANISM.
- 39. PERFORM A FINAL SYSTEM BALANCE ONLY WHEN THE SYSTEM IS COMPLETE AND CAPABLE OF OPERATING IN ACCORDANCE WITH THE DESIGN CONTROL SEQUENCES. COORDINATE THE SCHEDULE FOR THE SYSTEM BALANCE WITH ALL APPROPRIATE TRADES TO IDENTIFY AND CORRECT ANY DEFICIENCIES WHICH COULD RESULT IN AN INCOMPLETE BALANCE REPORT. INCOMPLETE BALANCE REPORTS WILL NOT BE ACCEPTED FOR REVIEW. BALANCING WILL ONLY BE CONSIDERED TO BE COMPLETE UPON RECEIPT OF AN APPROVED BALANCE REPORT FROM THE ENGINEER.

CONTROLS:

- 40. FURNISH ALL LABOR, MATERIALS, EQUIPMENT, AND DESIGN SERVICES REQUIRED TO PROVIDE A COMPLETE CONTROL SYSTEM. THIS WORK SHALL INCLUDE WORK REQUIRED BY ELECTRICAL CONTRACTOR AS WELL. PROVIDE INITIAL SETUP AND PROGRAMMING OF ALL CONTROLS.
- HEAT PUMPS SHALL BE CONTROLLED VIA WALL MOUNTED THERMOSTAT. SET THERMOSTATS 75 DEGREE FOR COOLING SEASON AND 70 DEGREE F FOR HEATING SEASON.

MECHANICAL SYMBOLS SYMBOL DESCRIPTION EXHAUST FAN · 8x8 -} DUCTWORK WITH SIZE INDICATION AIR FLOW DIRECTION REFERENCED PLAN NOTE DESIGNATION REFRIGERANT PIPING -RCONDENSATE DRAIN PIPING —___CD —_ **THERMOSTAT** PIPE GOING UP $\overline{}$ PIPE GOING DOWN $\overline{}$



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PROFESSIONAL SEAL & SIGN



04	06/12/25	PROGRESS SET
01	06/13/25	PROGRESS SET
02	06/18/25	CHECK SET
03	07/11/25	PERMIT SET
ISSU	E	

RUST MANOR

802 CHILDRENS CENTER RD LEESBURG, VA 20175

DRAWING TITLE: NOTES AND SYMBOLS-**MECHANICAL**

DRAWING NUMBER: COMM. NO: DRAWN: M100 CHECKED: SCALE: DATE:

	FAN SCHEDULE											
DESIGNATION	CFM	E.S.P. (W.G)	VOLTAGE V/PH/ HZ	RPM	POWER	DRIVE TYPE	FAN TYPE	CONTROL	MANUFACTURER AND MODEL (GREENHECK)			
EF-1	50	0.25	115/1/60	950	80 WATTS	DIRECT	CEILING	LIGHT SWITCH	SP-B110			
EF-2	150	0.25	115/1/60	1050	128 WATTS	DIRECT	CEILING	LIGHT SWITCH	SP-B150			
EF-3	150	0.25	115/1/60	1050	128 WATTS	DIRECT	CEILING	LIGHT SWITCH	SP-B150			

SCHEDULE NOTES:

1. PROVIDE ALL FANS WITH BACKDRAFT DAMPERS.

2. PROVIDE ALL DIRECT DRIVE FANS WITH FACTORY INSTALLED INTEGRAL SPEED CONTROLLER.

3. FANS SHALL BE UL LISTED.

4. COLOR OF GRILLE SHALL BE COORDINATED WITH ARCHITECT.

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	INDOOR UNIT SCHEDULE												
DESIGNATION	CORROSPONDING	SUPPLY AIR TOTAL	COOLING	CAPACITY	HEATING CAPACITY	ELECTR	ICAL DATA	MEIGHT (LDC)	DAIKINI MODEL NO				
DESIGNATION	OUTDOOR UNIT	L/M/H CFM	SENS (MBH)	TOTAL (MBH)	HEAT PUMP MODE(MBH)	MCA/MOCP	VOLTAGE V/PH/HZ	WEIGHT (LBS.)	DAIKIN MODEL NO.				
FCU-1	Existing HP	272	7.2	9	10	7.6/15	208-230/1/60	27	FTXR09WVJUW9				
FCU-2	Existing HP	272	7.2	9	10	7.6/15	208-230/1/60	27	FTXR09WVJUW9				
SCHEDULE N	NOTES												

SCHEDULE NOTES

1.COOLING DESIGN BASED ON 95°FDB AMBIENT OUTDOOR CONDITION, RETURN AIR TEMPERATURE 80°FDB, 67°FWB CONDITION.

2. HEATING DESIGN BASED ON 47°FDB, 43°FWB AMBIENT OUTDOOR CONDITION AND 70°FDB SPACE CONDITION.

B. PROVIDE AUXILLIARY DRAIN PAN UNDER THE COIL. PROVIDE FLOAT SWITCH IN PAN; WIRE UNIT THROUGH FLOAT SWITCH. FLOAT SWITCH TO SHUT OFF UNIT WHEN 4. PROVIDE UNITS WITH CONDENSATE PUMP/LIFT MECHANISM TO LIFT WATER UP TO 33".

5. CONTRACTOR TO FURNISH AND INSTALL INSULATED REFRIGERANT PIPING BETWEEN FCU'S AND CONDENSING UNITS. REFER TO PIPING MANUAL.

6. ESP IS EXCLUSIVE OF FILTERS, WET COIL, CASING LOSSES, AND HEATING COIL.

7. SUBMIT SHOP DRAWINGS FOR APPROVAL. 8. ALL EQUIPMENT SHALL BE INSTALLED BY CONTRACTOR CERTIFIED BY LG AND HAVING AT LEAST 5 YEARS OF EXPERIENCE IN INSTALLING SUCH SYSTEMS.

9. CONTRACTOR SHALL OBTAIN APPROVAL FROM MANUFACTURER'S REPRESENTATIVE FOR INSTALLATION PRIOR TO COMPLETION. CONTRACTOR SHALL ENGAGE

GILL ENGINEERING GROUP

REFERENCED PLAN NOTES Applicable to this drawing only

- 1 EXISTING TO REMAIN HEAT PUMP ON GRADE. CONTRACTOR SHALL CHECK UNIT FOR WORKING ORDER. NOTIFY LANDLORD/TENANT OF ANY DEFICIENCY. FIELD COORDINATE LOCATION.
- DEMOLITION FLOOR MOUNTED FAN COIL UNIT. HAND IT BACK TO LANDLORD/TENANT FOR FUTURE USE. FIELD COORDINATE DEMOLITION WORK.
- RELOCATE WALL MOUNTED FAN COIL UNIT DAIKIN MODEL FTX\$12LVJU. RECONNECT PIPING AS NECESSARY TO NEW LOCATION. FIELD COORDINATE WORK.
- 4 NEW WALL MOUNTED FAN COIL UNIT. INSTALL AS PER MANUFACTURING RECOMMENDATION. FIELD COORDINATE INSTALLATION WORK.
- 5 REFRIGERANT PIPING IN CEILING SPACE. FIELD COORDINATE ROUTING.
- 6 3/4" CONDENSATE DRAIN PIPING GO DOWN TO BASEMENT. FIELD COORDINATE ROUTING AND DISCHARGE LOCATION.
- 7 NEW THERMOSTAT BY FAN COIL UNIT MANUFACTURER. FIELD COORDINATE LOCATION.
- 8 NEW BATHROOM EXHAUST FAN. FIELD COORDINATE LOCATION.
- 9 NEW BATHROOM EXHAUST DUCT IN CEILING SPACE. FIELD COORDINATE ROUTING.
- NEW LOUVER BY GREENHECK MODEL EDD-401 OR APPROVED EQUAL. CONTRACTOR SHALL PROVIDE METAL BOX FOR DUCTWORK CONNECTION. FIELD COORDINATE INSTALLATION WORK.

LEGEND

FCU FAN COIL UNIT

(E) EXISTING TO REMAIN

HP HEAT PUMP

T THERMOSTAT

EF EXHAUST FAN



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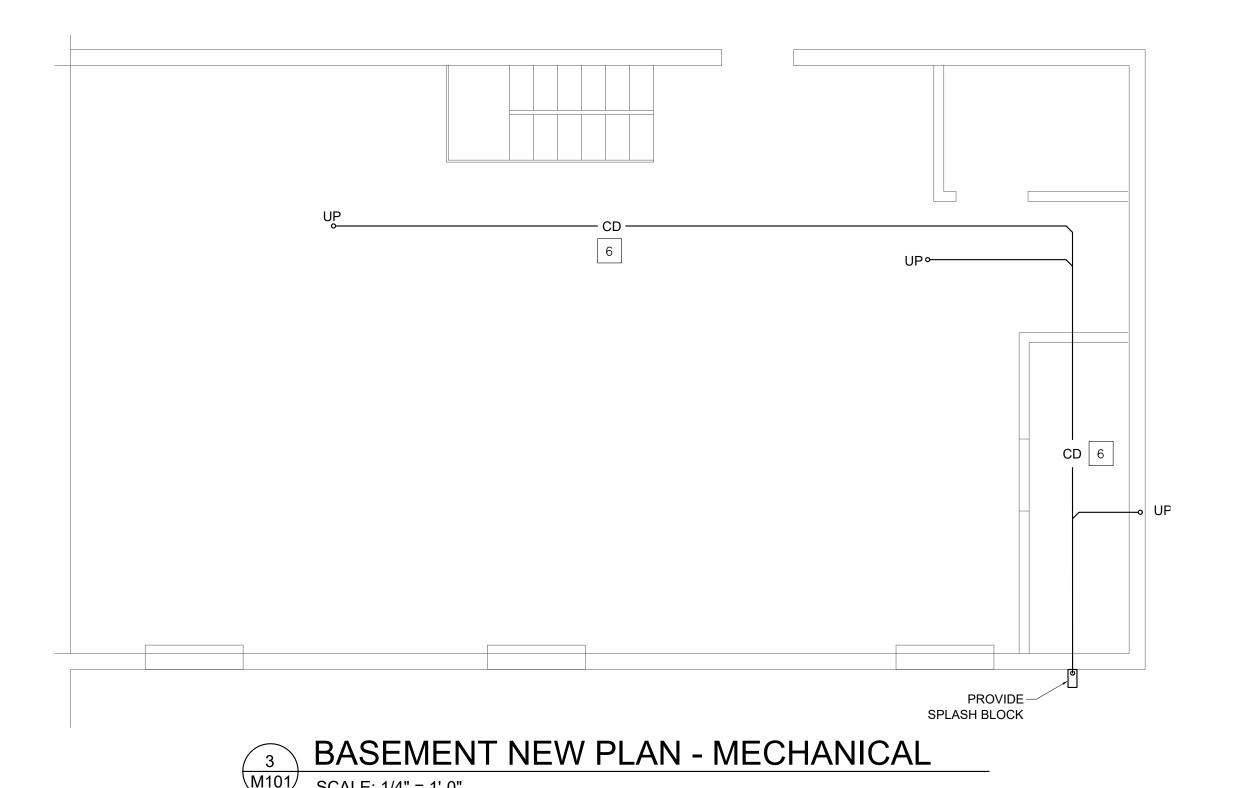
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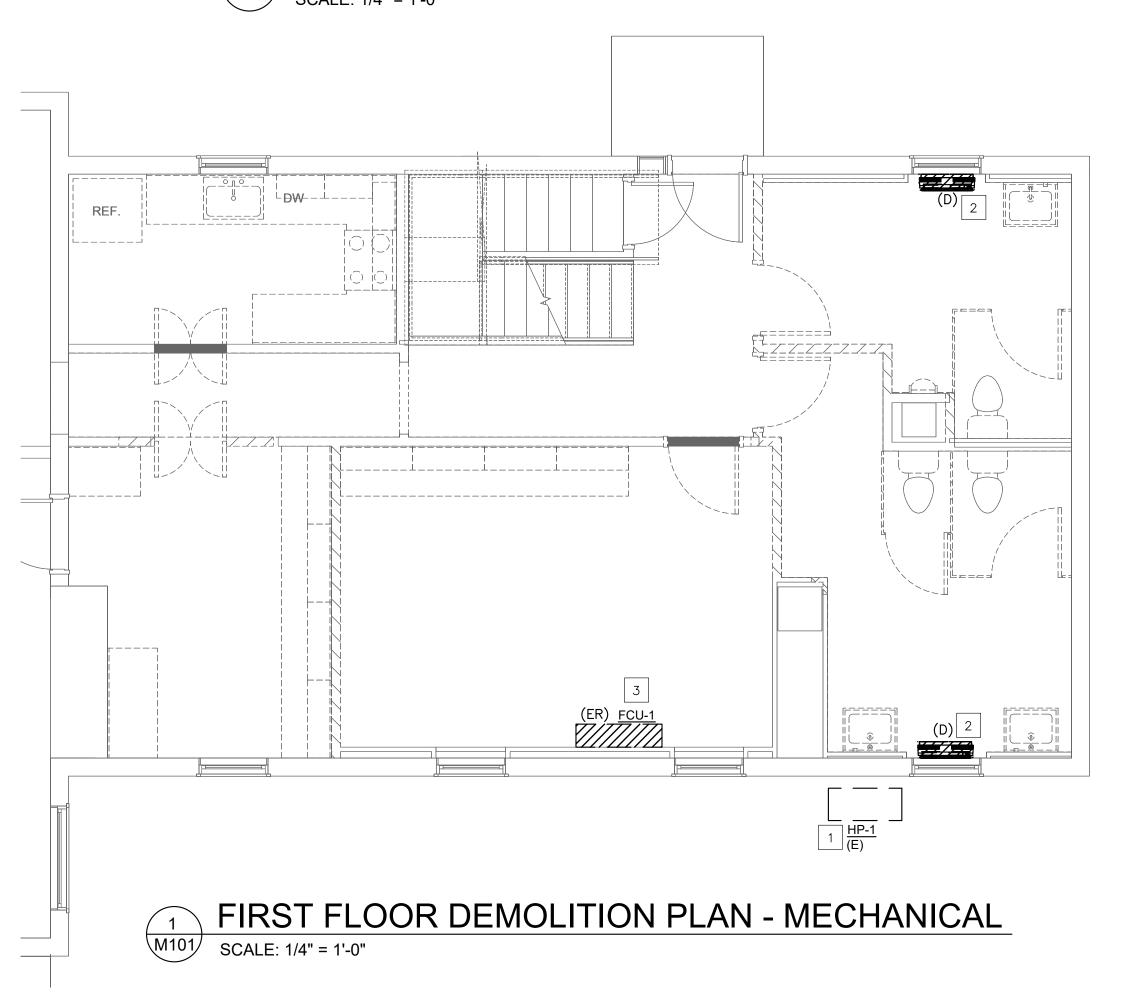
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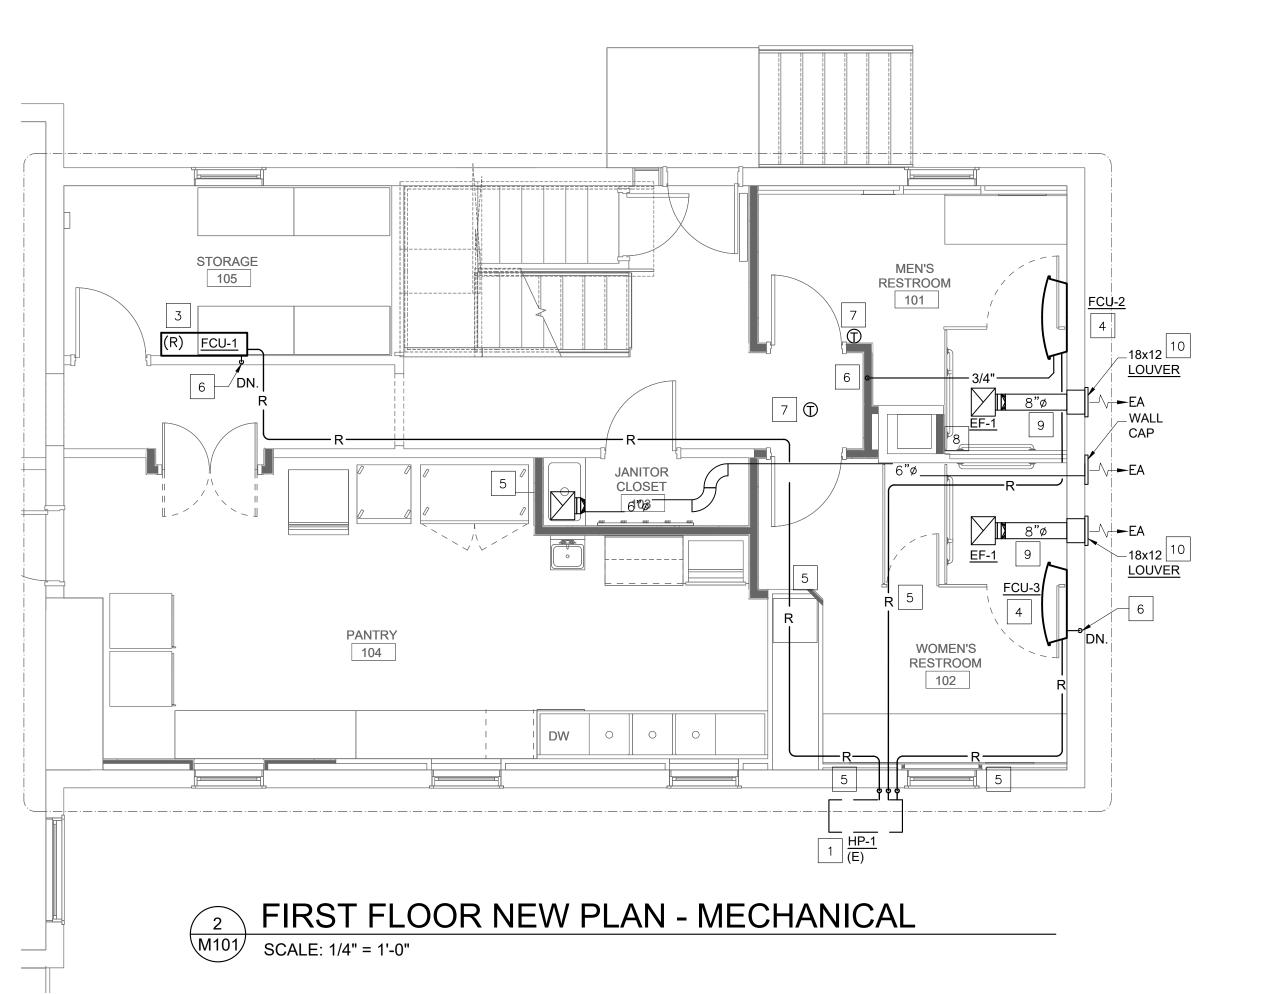
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DRAWING TITLE: FLOOR PLANS - MECHANICAL

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PLUMBING SPECIFICATION NOTES

- . HORIZONTAL SANITARY AND WASTE PIPING SHALL SLOPE AT 1/4" PER FOOT FOR ALL PIPING UP TO AND INCLUDING 2-1/2" AND SHALL SLOPE AT 1/8" PER FOOT FOR ALL PIPING 3" AND LARGER.
- 2. PIPING SHALL BE ROUTED ABOVE CEILINGS AND SHALL BE CONCEALED WITHIN WALLS WHEREVER POSSIBLE.
- 3. ALL DOMESTIC WATER PIPING SYSTEMS SHALL BE TESTED AND CLEANED IN ACCORDANCE WITH THE APPLICABLE CODES.
- 4. THE CONTRACTOR SHALL HYDRAULICALLY PRESSURE TEST ALL PIPING AT THE FULL WORKING PRESSURE FOR A MINIMUM PERIOD OF 24-HOURS. STOP-LEAK COMPOUNDS WILL NOT BE ALLOWED. ALL PRESSURIZED WATER PIPING SYSTEMS SHALL BE RATED FOR 150 PSI WORKING
- 5. SANITARY, SOIL OR WASTE PIPE SHALL NOT EXTEND GREATER THAN 2'-0" TO A DEAD-END. PROVIDE CLEAN-OUTS AS REQUIRED BY THE LOCAL AUTHORITIES.
- 6. CONNECTIONS BETWEEN DISSIMILAR PIPING MATERIALS SHALL BE MADE WITH SUITABLE DIELECTRIC INSULATING UNIONS.
- 7. ALL PIPING SHALL BE SUPPORTED WITH U.L. LISTED HANGERS AND SUPPORTS SUITABLE FOR THE INTENDED INSTALLATION. DESIGN, SELECTION, SPACING AND APPLICATION OF HANGERS AND SUPPORTS SHALL COMPLY WITH ANSI B31.1 AND MSS SP-69. PIPING SUPPORTS ON ALL DOMESTIC WATER LINES 1-1/4" OR LARGER SHALL BE SUPPORTED TWICE AS FREQUENTLY AS INDICATED IN LISTED STANDARDS.
- 8. SOLDERED COPPER JOINTS SHALL BE SOLDERED WITH LEAD FREE ASTM B22 GRADE 95T TIN-ANTIMONY SOLDER.
- 9. ALL NEW DOMESTIC COLD AND HOT WATER DISTRIBUTION SYSTEM ALONG WITH FIXTURE FAUCETS AND OTHER END-USE DEVICES SHALL BE LEAD FREE.
- 10. ALL NEW COLD WATER SERVICE PIPING SHALL BE RATED FOR NOT LESS THAN 200 PSIG AT 73°F TYPE CPVC (ASTM F442) SD-PR COMPOSED OF CPVC 4120 (23447) SDR 21 OR LOWER NON THREADED OR APPROVED EQUAL.
- 11. ALL NEW DOMESTIC HOT AND COLD WATER DISTRIBUTION PIPING SHALL BE RATED FOR NOT LESS THAN 100 PSI AT 180 ° F AT 160 PSI AT 73° F TYPE CPVC (ASTM D2846) COMPOSED OF CPVC 4210 SDR 11 NON THREADED OR APPROVED EQUAL.
- 12. INSULATE HOT WATER PIPING WITH R-3 FIBER GLASS INSULATION. CONTRACTOR HAS AN OPTION TO INSTALL R-3 UNICELLULAR FOAM INSULATION.
- 13. PIPING AND FITTINGS SHALL BE INSTALLED IN ACCORDANCE WITH THE MANUFACTURER'S INSTALLATION INSTRUCTIONS AND THE ACCEPTABLE MATERIAL STANDARDS, RECOGNIZING ANY LIMITATIONS IN USE.
- 14. GATE VALVES SHALL BE USED FOR STOP OR ISOLATION VALVE APPLICATIONS. IN LIEU OF GATE VALVES FOR PIPING 2-1/2" AND SMALLER, BALL VALVES MAY BE USED.
- 15. ALL NEW DOMESTIC HOT AND COLD WATER VALVES SHALL BE CPVC BALL VALVE SOLVENT
- 16. ALL NEW SANITARY, SOIL, WASTE, VENT, WATER PIPING SHALL BE SERVICE WEIGHT SCHEDULE 40 PVC CONFORMING TO ASTM D 2665; ASTM F 1488.
- 17. BACKFLOW PREVENTER (BFP) WALL HYDRANT ASSE 1011; ALL BACK FLOW PREVENTION DEVICES SHALL BE CITY APPROVED.
- 18. THE CONTRACTOR SHALL MAKE ALL EQUIPMENT AND FIXTURE CONNECTIONS.
- 19. VACUUM RELIEF VALVE (VRV): WATTS N36 (ANSI Z21.22).
- 20. THE CONTRACTOR IS PROHIBITED FROM USING LEAD-BASED SOLDER ON DOMESTIC POTABLE
- 21. THE CONTRACTOR SHALL MAKE ALL EQUIPMENT AND FIXTURE CONNECTIONS.
- 22. ALL WALL HYDRANTS SHALL BE PROVIDED WITH INTEGRAL VACUUM BREAKERS.

PLUMBING GENERAL NOTES

- PROVIDE COMPLETE AND PROPERLY FUNCTIONING PLUMBING SYSTEMS FOR THIS PROJECT. VISIT THE PROJECT SITE, EXAMINE THESE PLANS AND ALL TRADE DRAWINGS RELATING TO THE AREA OF WORK, AND REPORT ANY DISCREPANCIES OR OMISSIONS IN THIS PLAN SET TO THE ENGINEER FOR RESOLUTION AND CLARIFICATION PRIOR TO SUBMISSION OF BIDS. BY SUBMITTING A BID ON THIS PROJECT, THE CONTRACTOR ACCEPTS THESE DOCUMENTS AS AN ADEQUATE DEFINITION OF THE SCOPE OF WORK. CLAIMS FOR ADDITIONAL COSTS TO ACHIEVE THE INTENDED SCOPE OF WORK WILL NOT BE ACCEPTED.
- 2. IT IS THE INTENT OF THE CONTRACT DOCUMENTS TO INDICATE FINISHED WORK THAT IS FULLY ADJUSTED, TESTED, AND READY FOR OPERATION. WHEREVER THE WORD "PROVIDE" IS USED, IT SHALL MEAN "FURNISH AND INSTALL COMPLETE AND READY FOR USE", UNLESS OTHERWISE NOTED.
- INSTALL ALL WORK ON THIS PROJECT IN ACCORDANCE WITH THE 2021 VIRGINIA STATE /INTERNATIONAL PLUMBING CODE, 2021 VIRGINIA ENERGY CONSERVATION CODE, NFPA 90 ALONG WITH ALL REFERENCED CODES AND LOCAL REGULATIONS.
- OBTAIN AND PAY FOR ALL PERMITS ASSOCIATED WITH THIS PROJECT PRIOR TO STARTING OF WORK AND ARRANGE ALL REQUIRED INSPECTIONS BY THE APPROPRIATE LOCAL AUTHORITIES.
- 5. THE CONTRACTOR SHALL FURNISH AND INSTALL ALL ITEMS NECESSARY FOR THE COMPLETE INSTALLATION OF THE EQUIPMENT AS PER CODE WITHOUT ADDITIONAL COST TO THE OWNER, REGARDLESS WHETHER THE ITEMS ARE INDICATED IN THE CONTRACT DRAWINGS OR SPECIFICATIONS. SUCH ITEMS COULD BE, BUT ARE NOT LIMITED TO, SUPPORTS, INSULATION, WIRING, LUBRICATION, MOTOR CONTROLLERS, START-UP AND SERVICE, ETC.
- 6. THE CONTRACTOR SHALL FURNISH AND INSTALL A FIRST CLASS SYSTEM AND SHALL COMPLETELY COORDINATE WITH ALL OTHER TRADES.
- 7. THE CONTRACTOR SHALL INSTALL ALL EQUIPMENT IN ACCORDANCE WITH MANUFACTURERS RECOMMENDATIONS.
- 8. THE CONTRACT DRAWINGS ARE DIAGRAMMATIC AND DO NOT INDICATE ALL COMPONENTS AND ACCESSORIES REQUIRED FOR THE COMPLETE INSTALLATION. THE CONTRACTOR SHALL PROVIDE SUCH ITEMS TO COMPLETE THE ENTIRE SYSTEM AND PLACE IN PROPER OPERATION IN ACCORDANCE WITH APPLICABLE CODES, INDUSTRY STANDARDS, AND EQUIPMENT MANUFACTURER'S RECOMMENDATIONS.
- . LOCATIONS OF EQUIPMENT, PIPING, VALVES, ETC. ARE INDICATED DIAGRAMMATICALLY ON THE DRAWINGS. THE CONTRACTOR SHALL OBTAIN EXACT LOCATIONS AND ESTABLISH EXACT DIMENSIONS ON THE JOB SITE AFTER STUDYING THE CONDITIONS.
- 10. THE CONTRACTOR SHALL BE RESPONSIBLE FOR INSTALLING ALL ADDITIONAL FITTINGS AND REROUTING OF PIPING TO ASSURE THE PIPING SYSTEMS ARE INSTALLED PROPERLY AND IN ACCORDANCE WITH CODE.
- 11. ALL NEW SYSTEMS SHALL BE PURGED, CLEANED AND TESTED BY THE CONTRACTOR UPON COMPLETION OF THE PROJECT. ALL PIPING SYSTEMS SHALL BE COMPLETELY LEAK AND PRESSURE TESTED PRIOR TO EQUIPMENT START-UP. DOMESTIC HOT AND COLD WATER SYSTEM SHALL BE DISINFECTED BY APPROVED MEANS PRIOR TO PUT INTO SERVICE. IT SHALL BE ESTABLISHED THAT ALL EQUIPMENT IS CAPABLE OF OPERATING AT THE DESIGN CAPACITY TO THE SATISFACTION OF THE OWNER.
- 12. THE CONTRACTOR SHALL PROVIDE ACCESS DOORS IN WALLS AND CEILINGS TO MAINTAIN ACCESS TO VALVES.
- 13. ALL PIPING SHALL BE CONCEALED ABOVE CEILINGS, WITHIN WALLS, AND WITHIN CHASES UNLESS OTHERWISE NOTED. SOME ARE SHOWN OUTSIDE ON PLANS FOR CLARITY.
- 14. MOUNT ADA PLUMBING FIXTURES IN ACCORDANCE WITH ANSI AND ADA REQUIREMENTS, ARCHITECTURAL DRAWINGS.
- 15. PROVIDE NFPA APPROVED FIRE STOPPING AT ALL PIPING PENETRATIONS OF FIRE RATED FLOORS, WALLS, AND COMPONENTS.
- 16. PROVIDE AND INSTALL CLEANOUTS IN DRAINAGE PIPING AT EVERY CHANGE IN DIRECTION OF PIPING GREATER THAN 45 DEGREES, EVERY 100 LINEAR FEET, AND AS INDICATED ON THE DRAWINGS. ALL CLEANOUT PLUGS SHALL BE REMOVED, THREADS DOPED, AND PLUGS REPLACED PRIOR TO COMPLETION OF PROJECT.
- 17. ALL DOMESTIC COLD AND HOT WATER PIPING PIPES SHALL BE INSULATED.
- 18. THE CONTRACTOR SHALL GUARANTEE ALL WORKMANSHIP, MATERIALS, EQUIPMENT, AND RELATED ITEMS FOR A PERIOD AFTER COMPLETION OF THE PROJECT AND REPLACE ANY DEFECTIVE MATERIALS, EQUIPMENT, AND RELATED ITEMS WITHIN THE GUARANTEE PERIOD.
- 19. THE PERIOD SHALL BE TWELVE MONTHS FROM THE COMPLETION OF THE PROJECT UNLESS SPECIFIED OTHERWISE IN THE SPECIFICATIONS OR CONTRACT DOCUMENTS.
- 20. ALL CONTRACT DOCUMENTS INCLUDING ARCHITECTURAL, STRUCTURAL, ELECTRICAL, MECHANICAL. AND PLUMBING ARE COMPLEMENTARY AND MUST BE USED IN COMBINATION BY THE CONTRACTOR TO OBTAIN COMPLETE CONSTRUCTION INFORMATION AND PROVIDE A COMPLETE OPERABLE SYSTEM.
- 21. FREEZE PROTECT PIPING EXPOSED TO OUTDOOR TEMPERATURES.
- 22. REFER TO THE SPECIFICATIONS FOR ADDITIONAL INFORMATION.

ABBREVIATIONS

ABBREVIATION	DESCRIPTION
ABV	ABOVE
AFF	ABOVE FINISHED FLOOR
ARCH	ARCHITECTURAL
BEL	BELOW
BFP	BACK FLOW PREVENTER
BTU	BRITISH THERMAL UNIT
CD	CONDENSATE DRAIN
CI	CAST IRON
CFH	CUBIC FEET PER HOUR
СО	CLEAN-OUT
CONN	CONNECTION
CONT	CONTINUATION
CW	COLD WATER
DEG	DEGREES
DFU	DRAINAGE FIXTURE UNITS
DF	DRINKING FOUNTAIN
DIA	DIAMETER
DN	DOWN
DS	DOWNSPOUT
DWG	DRAWING
EA	EACH
ELECT	ELECTRICAL
EWH	ELECTRIC WATER HEATER
E OR ETR	EXISTING TO REMAIN
F	FAHRENHEIT
FD	FLOOR DRAIN
FLR	FLOOR
GPH	GALLONS PER HOUR
GPM	GALLONS PER MINUTE
HB	HOSE BIBB
HC	HANDICAP
HW	HOT WATER
KW	KILOWATT
LAV	LAVATORY
MAX	MAXIMUM
MBH	1000 BRITISH THERMAL UNITS PER HOUR
MECH	MECHANICAL
MIN	MINIMUM
MTD	MOUNTED MOD SINK
MS	MOP SINK
NIC	NOT IN CONTRACT
OSD	OPEN SPACE DRAIN
PH	PHASE
SAN	SANITARY
SK	SINK
TEMP	TEMPERATURE
TMV	THERMOSTATIC MIXING VALVE
TP	TRAP PRIMER
TYP	TYPICAL
UR	URINAL
V	VOLTAGE
VP	VENT PIPE
VTR	VENT THROUGH ROOF
WC	WATER CLOSET
VVC	

PLUMBING SYMBOLS

SYMBOL

DESCRIPTION

	SOIL OR WASTE ABOVE SLAB(SANITARY) PIPE
	EXISTING WASTE PIPE
FW	FILTERED WATER
	VENT PIPE
	EXISTING VENT PIPE
	NEW DOMESTIC COLD WATER PIPE
	EXISTING DOMESTIC COLD WATER PIPE
	105° F DOMESTIC HOT WATER PIPE
	HOT WATER CIRCULATING PIPE
CD	CONDENSATE DRAIN
D	DRAIN
T	VACUUM BREAKER
140°	140° HOT WATER PIPE
G	GAS PIPE
	PIPE TURN UP
	PIPE TURN DOWN
──	GATE VALVE
	GLOB VALVE
—— □ BFP	BACK FLOW PREVENTER
→	DOUBLE CHECK VALVE ASSEMBLY
$^{\not \!$	DRAIN VALVE WITH HOSE CONNECTOR END
	PRESSURE AND TEMPERATURE RELIEF VALVE
 	UNION
⊃ ⊘	FLOOR DRAIN
co <u> </u>	CLEAN OUT
DS-1	PLUMBING FIXTURE DESIGNATION
₽ ₽	WATER HAMMER ARRESTOR
*	THERMOSTATIC MIXING VALVE
<u> </u>	GATE VALVE OS&Y
<u> </u>	PRESSURE REDUCING VALVE
	SUB METER WITH REMOTE READER
	GAS PRESSURE REDUCING VALVE
<u> </u>	GAS COCK VALVE
	GAS REGULATING VALVE
0	POINT OF CONNECTION. NEW TO EXISTING
	THERMOMETER
1	INDICATES A DRAWING NOTE
W	PIPE OF SERVICE
P-1 /	PLAN OR DETAIL NUMBER
	ITEM TO BE DEMOLISHED
δ	CHROME PLATED BRASS 1/4 TURN ANGLE VALVE

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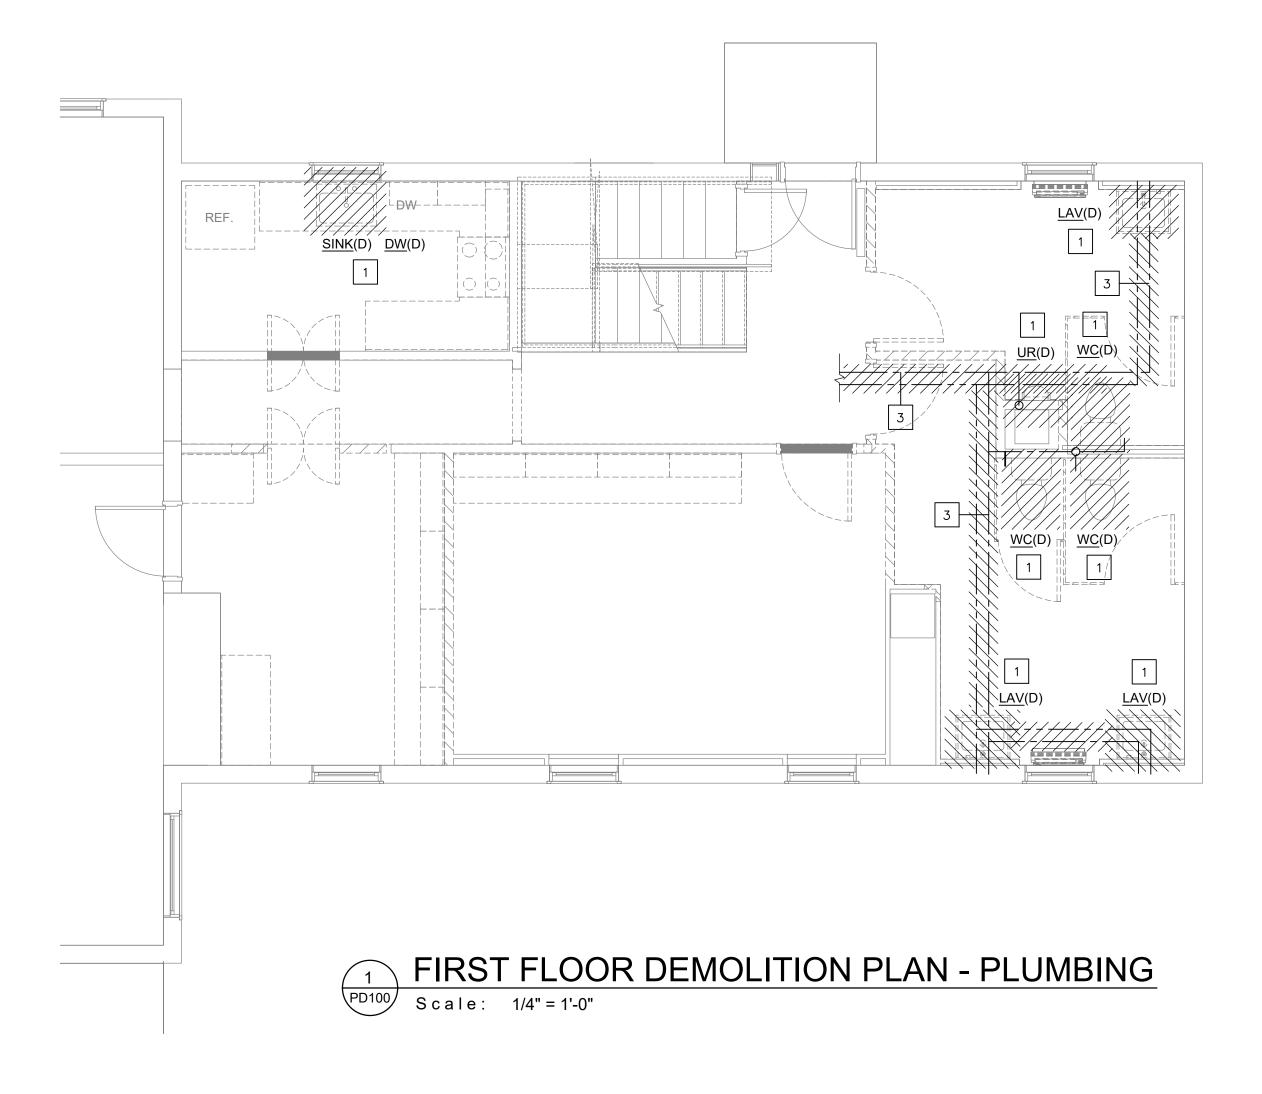
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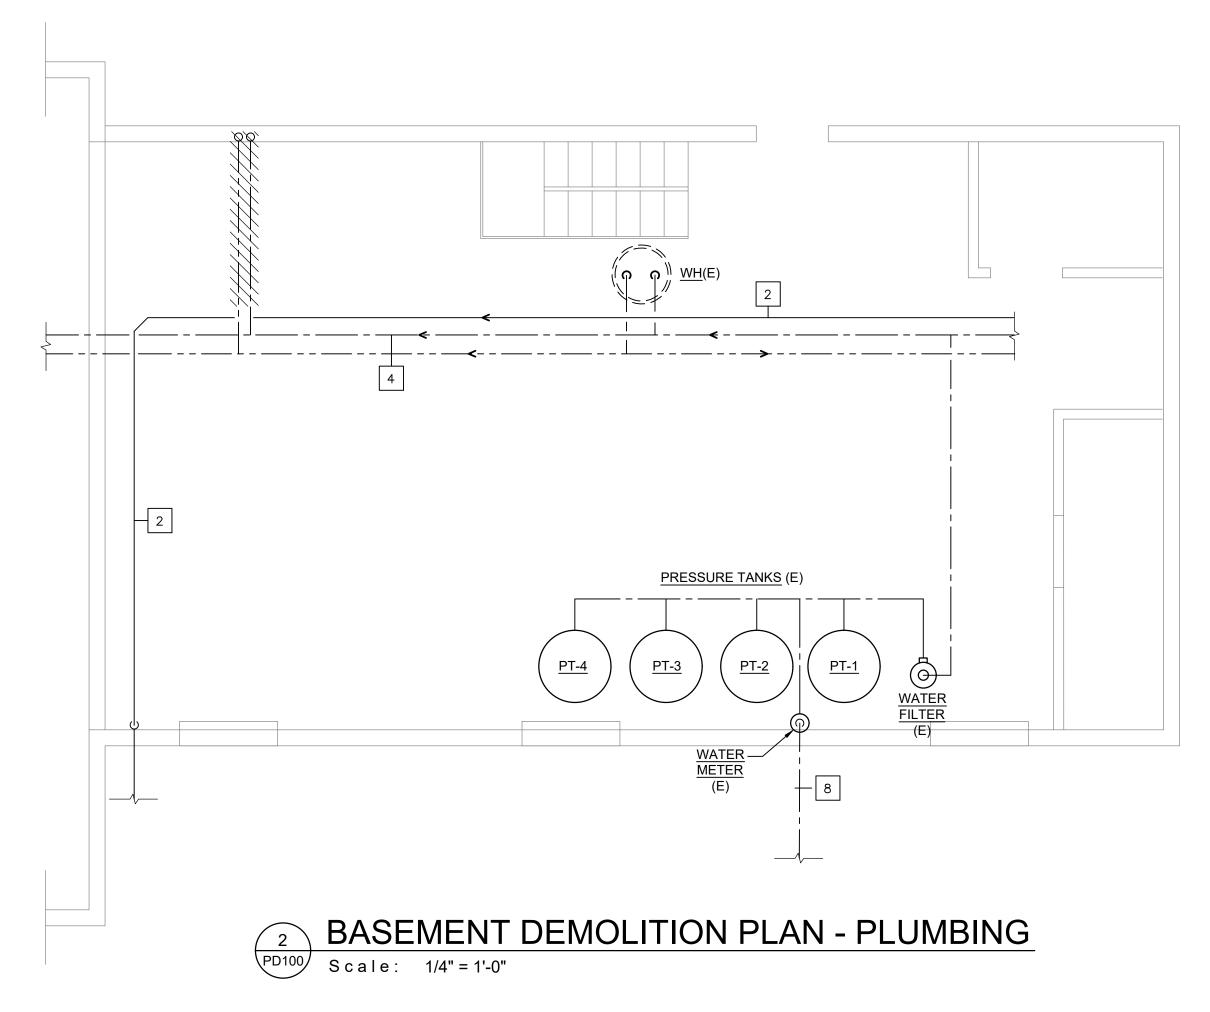
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DRAWING TITLE: NOTES AND SYMBOLS-

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LEGEND

- (D) TO BE DEMOLISHED
- (E) EXISTING TO REMAIN (ER) EXISTING TO BE RELOCATED
- (R) RELOCATED ITEM

REFERENCED PLAN NOTES Applicable to this drawing only

- REMOVE FIXTURE SAVE SANITARY AND VENT PIPES. REMOVE COLD/HOT WATER LINES. FIELD COORDINATE \Box DEMOLITION WORK.
- 2 EXISTING TO REMAIN SANITARY LINE AT CEILING LEVEL OF BASEMENT. FIELD COORDINATE EXACT LOCATION
- 3 REMOVE EXISTING COLD / HOT WATER LINES. FIELD COORDINATE DEMOLITION WORK.
- 4 EXISTING TO REMAIN COLD / HOT WATER LINES AT CEILING LEVEL. FIELD COORDINATE LOCATION.

GENERAL NOTES

- UTILITIES SHOWN ON PLAN MAY NOT MATCH WITH WHAT IS IN THE FIELD. CONTRACTOR TO FIELD VERIFY EXACT LOCATION OF ABOVE CEILING AND BELOW SLAB UTILITIES PRIOR TO STARTING OF
- LOCATE ALL BELOW SLAB UTILITIES, CONDUITS, PIPES ETC. IN THE CONSTRUCTION AREA PRIOR TO STARTING OF WORK.
- PERFORM WORK SUCH THAT MINIMUM MODIFICATION OF EXISTING SYSTEMS IS REQUIRED. DO NOT CLOSE CEILINGS UNLESS ALL BELOW SLAB WORK IS APPROVED AND INSPECTED BY PLUMBING
- . MAINTAIN ALL REQUIRED PIPE SLOPES. REFER TO SPECIFICATIONS FOR MORE
- . ALL PIPES SHALL BE RUN CONCEALED IN WALLS OR ABOVE CEILING.
- . CONTRACTOR SHALL REMOVE ALL PIPING THAT ARE NO LONGER REQUIRED.
- FLOOR PENETRATIONS AND OPEN SLAB CUTTING (TRENCHES) REQUIRE X-RAY OR GPR REPORTS AND APPROVAL OF THE REPORTS ARE REQUIRED PRIOR TO DRILLING OR CUTTING SLABS. PENETRATIONS OF THE FLOOR GREATER THAN 1 1/2" REQUIRE X-RAY/GPR, REVIEW, AND LAND LORD APPROVAL.
- CONTRACTOR TO COORDINATE ALL BELOW GRADE PIPING INSTALLATION WITH EXISTING FOOTER
- . ALL IN WET AREAS AND / OR BEHIND PLUMBING FIXTURES SHALL BE CONSTRUCTED OF MOISTURE RESISTANCE DRYWALL OR CEMENT BOARD WITH THE BOTTOM OF WALL CAULKED AT FLOOR LEVEL TO PREVENT MOISTURE INFILTRATION INTO BASE BUILDING ELEMENTS. WATERPROOFING TO BE PROVIDE BELOW NEW TILE IN WET AREAS.



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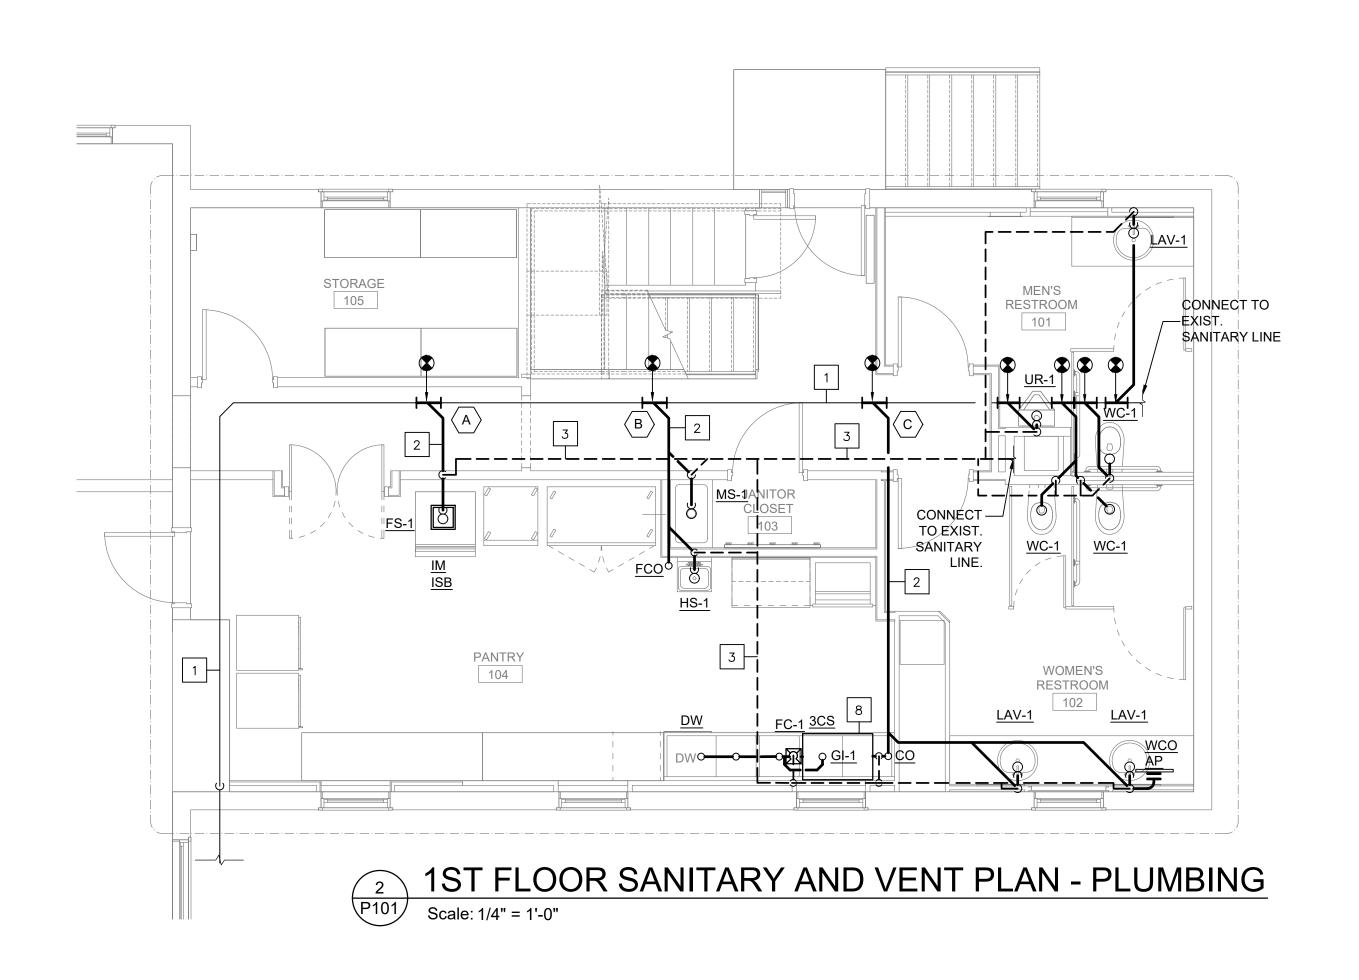
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DRAWING TITLE:

DEMOLITION PLANS-PLUMBING

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<u>UP</u> PRESSURE TANKS (E) BASEMENT DOMESTIC WATER PLAN - PLUMBING



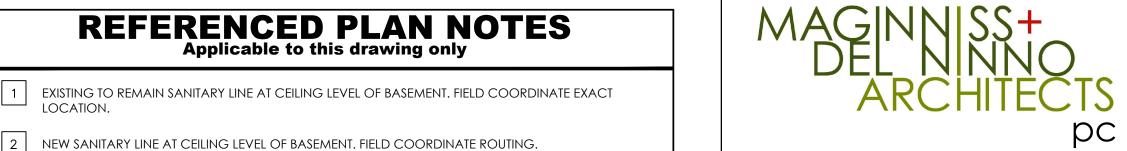
LEGEND

- (D) TO BE DEMOLISHED (E) EXISTING TO REMAIN
- (ER) EXISTING TO BE RELOCATED (R) RELOCATED ITEM

- EXISTING TO REMAIN SANITARY LINE AT CEILING LEVEL OF BASEMENT. FIELD COORDINATE EXACT LOCATION.
- 3 NEW VENT LINE CEILING LEVEL OF 1ST FLOOR. FIELD COORDINATE ROUTING.
- 4 EXISTING TO REMAIN COLD/HOT WATER LINES AT CEILING LEVEL OF BASEMENT. FIELD COORDINATE EXACT LOCATION.
- NEW COLD/HOT WATER AT CEILING LEVEL OF BASEMENT. FIELD COORDINATE ROUTING.
- 6 EXISTING TO REMAIN COLD WATER FROM WELL . FIELD COORDINATE EXACT LOCATION.
- NEW UNDER COUNTER GREASE INTERCEPTOR. (REFER SCHEDULE ON P103)

1/2" COLD WATER IN THE WALL CAVITY. FIELD COORDINATE ROUTING.

EXISTING ELECTRIC WATER HEATER TO REMAIN. CONNECT NEW HW LINE TO EXISTING HW LINE. FIELD COORDINATE THE ROUTING. CONTRACTOR TO VERIFY THE EXISTING WATER HEATER WORKING CONDITION AND REPLACE AND PROVIDE NECESSARY ACCESSORIES IF REQUIRED.



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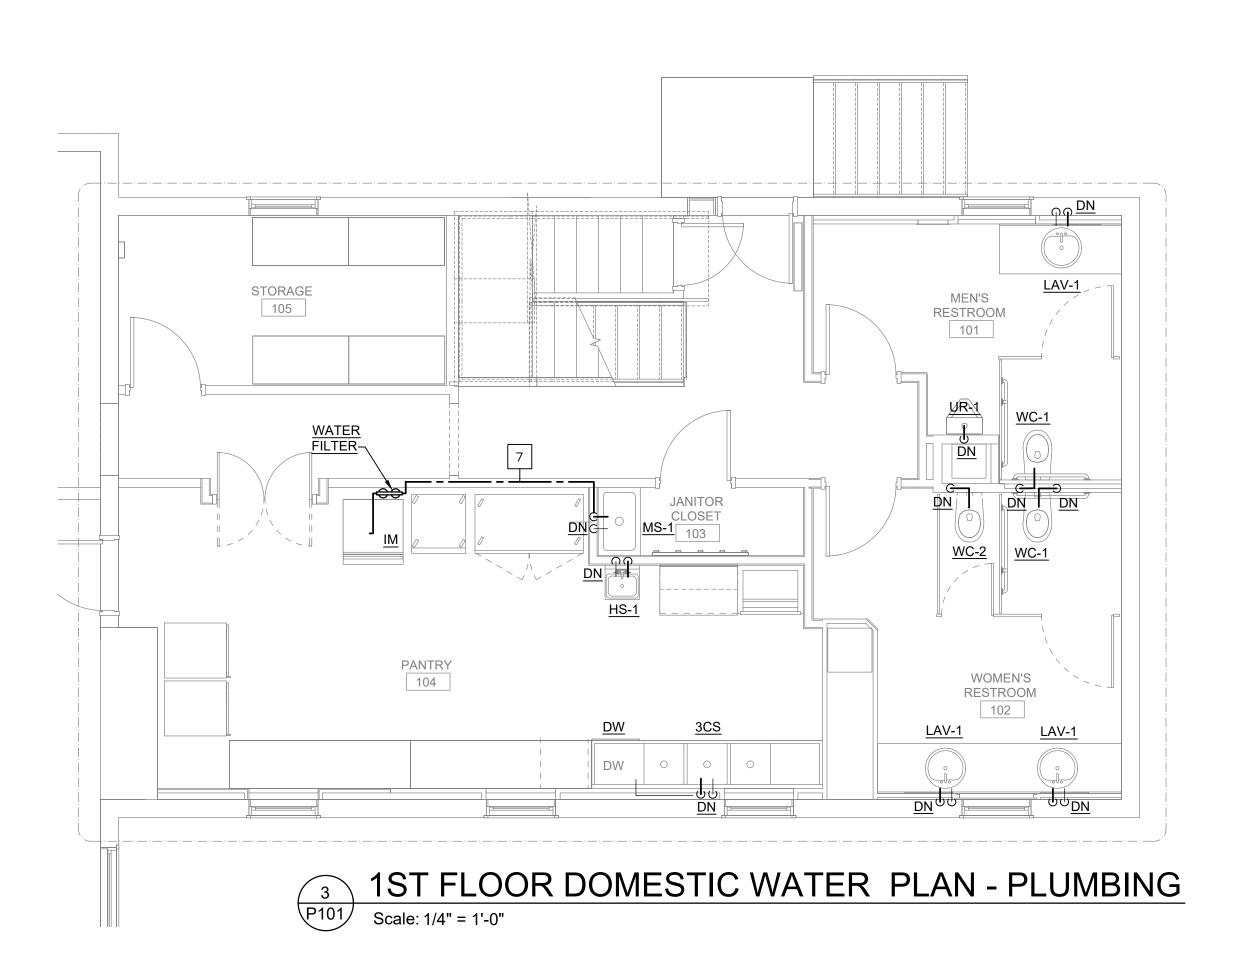
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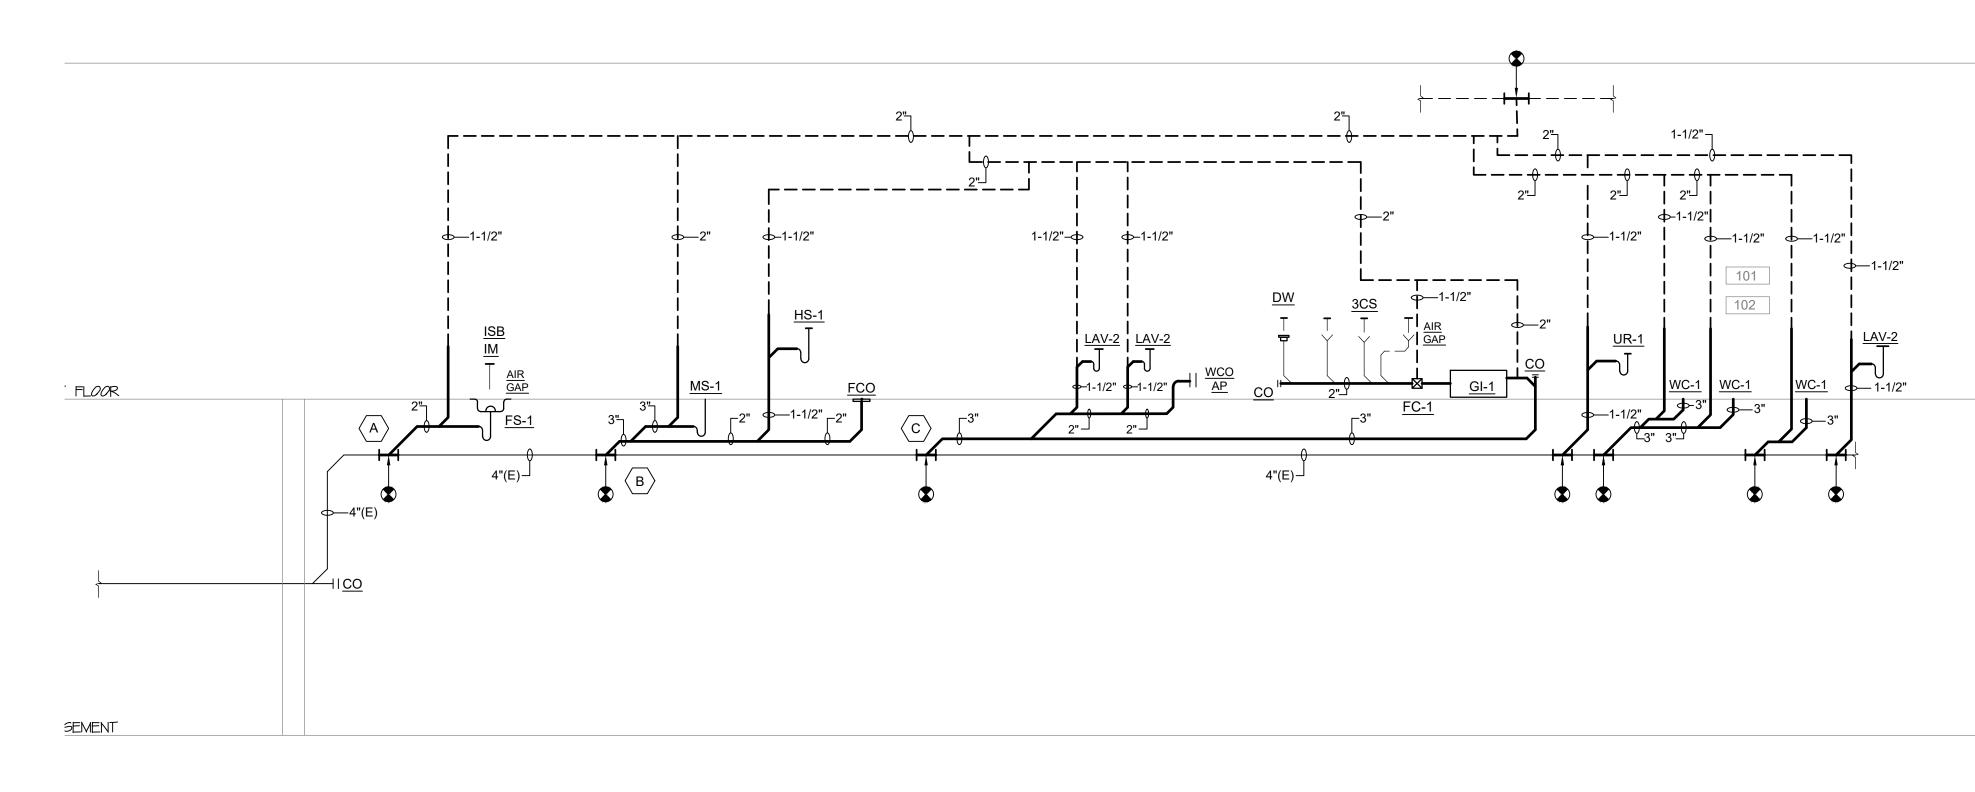
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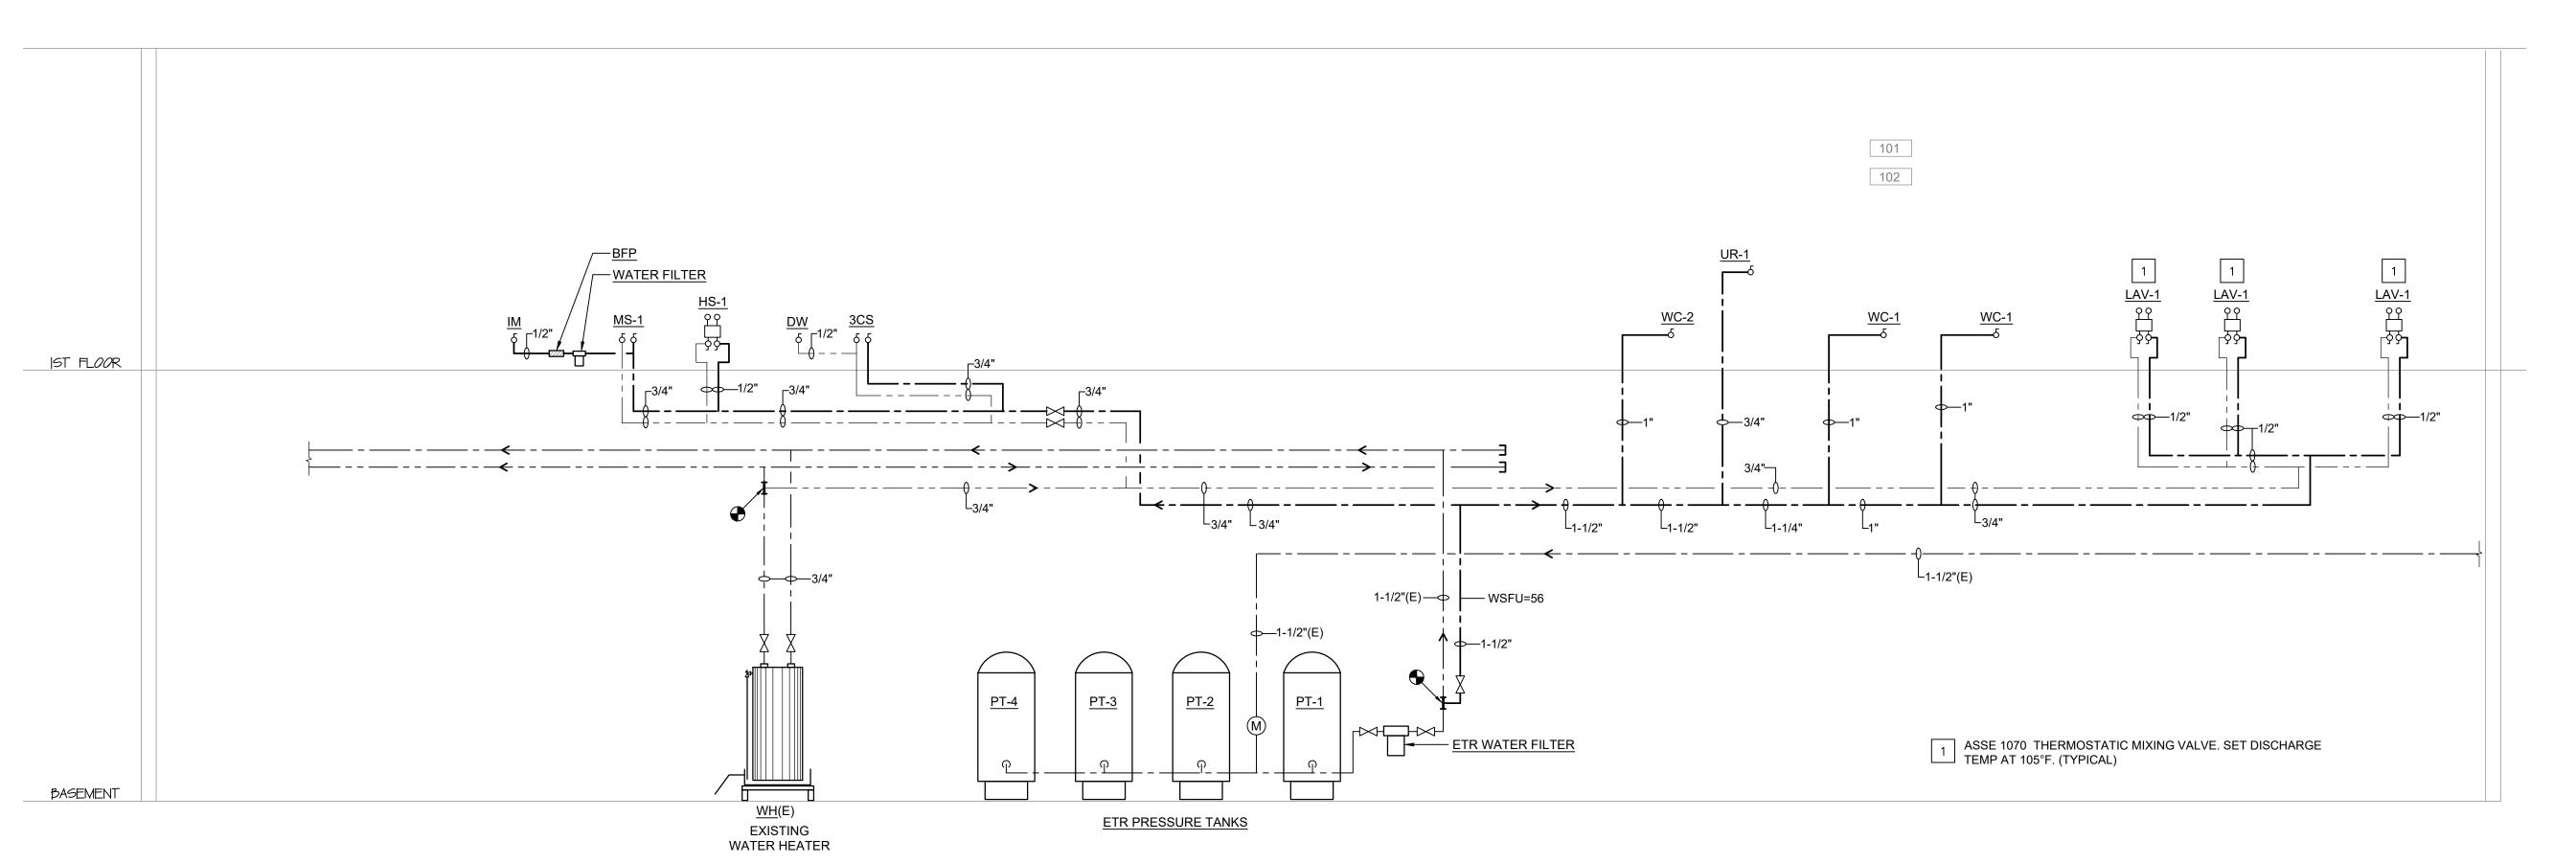
DRAWING TITLE: SANITARY , VENT & DOMESTIC WATER PLANS-PLUMBING

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SANITARY AND VENT RISER DIAGRAM - PLUMBING







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DRAWING TITLE:

RISER DIAGRAMS-PLUMBING

DRAWING NUMBER: COMM. NO: DRAWN: P102 CHECKED: SCALE:

	WATER HEATER SCHEDULE						
MARK	SPECIFICATION	STORAGE CAPACITY (GALLONS)	RECOVERY (GALLONS/HR @90° F)	ELECTRICAL INPUT (WATTS)	VOLTS PHASE HZ	HEATING ELEMENTS	
WH(E)	RHEEM XE50M06ST45U1	50	21	4,500	240/1/60	TWO 4500-WATTS ELEMENTS WIRED FOR NON SIMULTANEOUS OPERATION WITH 1 THERMOSTAT. SET TO STORE WATER AT 140° F.	

SCHEDULE NOTES

- STORAGE WATER HEATER SHALL BE UL LISTED AND TESTED.
- PROVIDE WATER HEATER WITH INTERNAL OVERLOAD AND OVER CURRENT PROTECTION DEVICE.
- PROVIDE ALL REQUIRED ACCESSORIES AND VALVES AS SHOWN IN DETAIL.
 PROVIDE BLADDER TYPE EXPANSION TANK AS SHOWN IN DETAIL.

GREASE INTERCEPTOR SCHEDULE							
MARK	DESCRIPTION	SPECIFICATION	FLOW RATE	CAPACITY	PIPE SIZE	NOTES	
GI-1	AUTOMATIC GREASE REMOVAL	BIG DIPPER PRO W-250-IS	25 GPM	56 POUNDS GREASE STORAGE	2"		
FC-1	FLOW CONTROL FOR GREASE INTERCEPTOR		25 GPM		2"		

			PLUM	BING F	IXTUI	RE CONN	ECTION	AND SPECIF	FICATION	SCHEDULE	
			MINIMUM F	IXTURE CONN	ECTION PIPE	SIZE			_	SPECIFICATIONS	
FIXTURE ID	FIXTURE DESCRIPTION	WASTE (INCHES)	VENT (INCHES)	HOT WATER (INCHES)	COLD WATER (INCHES)	TEMPERED WATER (INCHES)	MOUNTING	MANUFACTURER	MODEL NUMBER	DESCRIPTION	REMARKS
WC-1	WATER CLOSET MANUAL FLUSH VALVE TOP SPUD	3	2	_	1	_	FLOOR	AMERICAN STANDARD	MADERA 2854.016	FLOOR MOUNTED VITREOUS CHINA- WHITE, ELONGATED BOWL, 16-1\2" RIM HEIGHT, 1.6 GALLONS PER FLUSH.	MOUNT AS PER ADA AND ANSI
	ADA COMPLIANT				_			CHURCH	9500C	OPEN SEAT LESS COVER-WHITE	A117.1 REQUIREMENTS
								SLOAN	111-1.6 GPF	MANUAL OPERATED CHROME PLATED FLUSH VALVE	
WC-2	WATER CLOSET	2	2		1		FLOOR	AMERICAN STANDARD		FLOOR MOUNTED VITREOUS CHINA- WHITE, ELONGATED BOWL, 16-1\2" RIM HEIGHT, 1.6 GALLONS PER FLUSH.	
VVC-2	MANUAL FLUSH VALVE TOP SPUD	3	2	-	1	-	FLOOR	CHURCH	9500C	OPEN SEAT LESS COVER-WHITE	
								SLOAN	111-1.6 GPF	MANUAL OPERATED CHROME PLATED FLUSH VALVE	
	URINAL MANUAL OPERATED FLUSH							AMERICAN STANDARD		WALL HUNG VITREOUS CHINA WHITE- 1.0 GALLON PER FLUSH	MOUNT AS PER ADA AND ANSI
UR-1	VALVE ADA COMPLIANT	2	1-1\2	-	3\4	-	WALL	SLOAN	180-1.0	MANUAL OPERATED CHROME PLATED FLUSH VALVE	A117.1 REQUIREMENTS
101/1	LAVATORY	1.1\2	1 1\2		1\2	1) 2	UNDERMOUNT	KOHLER	CAXTON K-2210	UNDERMOUNT VITREOUS CHINA- COLOR AS SPECIFIED BY ARCHITECT WITH UNDERMOUNT CLAMPS, CHROME PLATED P-TRAP.	MOUNT AS PER ADA AND ANSI
LAV-1	MANUAL LEVER FAUCET	1-1\2	1-1\2	-	1\2	1\2	DECK	KOHLER	I K-13461	CHROME PLATED, 0.5 GPM; SET MAXIMUM CLOSE TIME TO 27 SECONDS.	A117.1 REQUIREMENTS
							CABINET	SLOAN	MIX-135-A	BELOW DECK THERMOSTATIC MIXING VALVE	

NOTES:

- 1. ALL FIXTURES SHALL BE APPROVED BY OWNER\ARCHITECT PRIOR TO ORDERING.
- 2. MINIMUM PIPE SIZE BELOW SLAB SHALL BE 2 INCHES.
- 3. PROVIDE INSULATION KIT ON ALL HANDICAP LAVATORIES. MANUFACTURER- TRUEBRO OR EQUAL.
- 4. GANGED AC POWERED LAVATORIES SHALL BE PROVIDED WITH SINGLE TRANSFORMER. (CONNECTED LOAD ON TRANSFORMER SHALL NOT EXCEED 50VA)REFER TO MANUFACTURER INSTRUCTIONS.

	KITCHEN EQUIPMENT PLUMBING SCHEDULE							
ITEM NO	QTY	EQUIPMENT CATEGORY	MANUFACTURER	COLDWATER SIZE(IN)	HOTWATER SIZE(IN)	DIRECTDRAIN SIZE(IN)	INDIRDRAIN SIZE(IN)	
MS-1	1	MOP SINK W/ACCESSORIES	ADVANCE TABCO	3/4	3/4	3		
IM	1	ICE MAKER	HOSHIZAKI AMERICA, INC. KML-325MAJ	1/2			3/4	
ISB	1	ICE STORAGE BIN	HOSHIZAKI AMERICA, INC. B-250PF				3/4	
HS-1	1	HAND SINK	ADVANCE TABCO 7-PS-61	1/2	1/2	2		
DW	1	SANITATIZNG DISHWASHER	GENERAL ELECTRIC		1/2		1/2	
3CS	1	THREE COMPARTMENT SINK	EAGLE GROUP FN 2060-3-24-14/3	3/4	3/4		2(#3)	

GREASE INTERCEPTOR SIZING

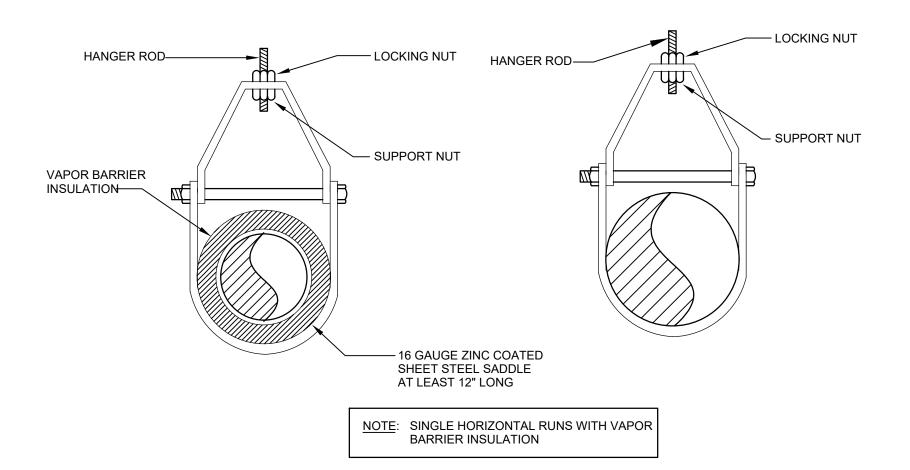
3-COMPARTMENT SINK
WASH COMPARTMENT 20"x20"x14" = 5600 UBIC INCHES
RINSE COMPARTMENT 20"x20"x14" = 5600 CUBIC INCHES
SANITIZE COMPARTMENT 20"x20"x14" = 5600 CUBIC INCHES

G1-1

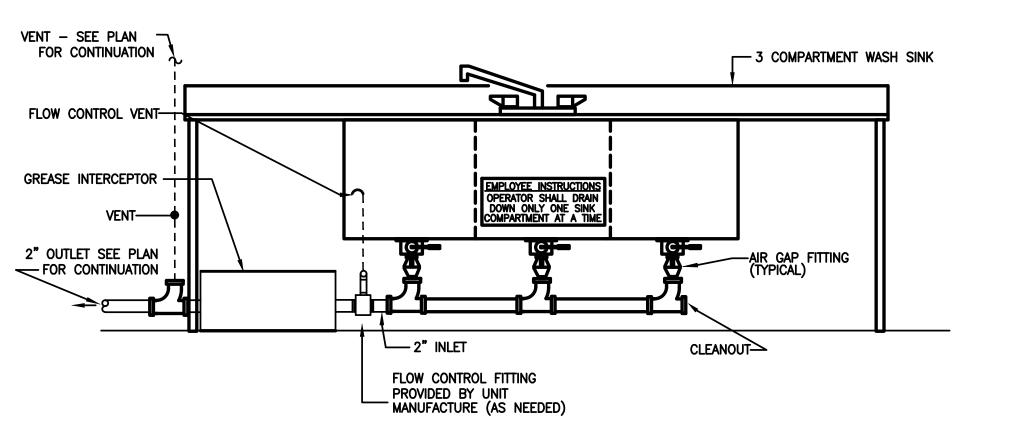
5600x3x0.75 = 12600 CUBIC INCHES CAPACITY
12600 CUBIC INCHES/231 CUBIC INCHES/GALLON = 54.54 GALLONS.

DRAINAGE LOAD. 54.54 GALLONS/2 MINUTE DRAIN PERIOD = 27.27 GPM
MINIMUM DISCHARGE RATE.
INSTALL GREASE INTERCEPTOR RATED AT 25 GPM FLOW RATE AND 56.4
POUNDS OF GREASE STORAGE CAPACITY. PROVIDE FLOW CONTROL

DEVICE RATED AT 25 GPM.











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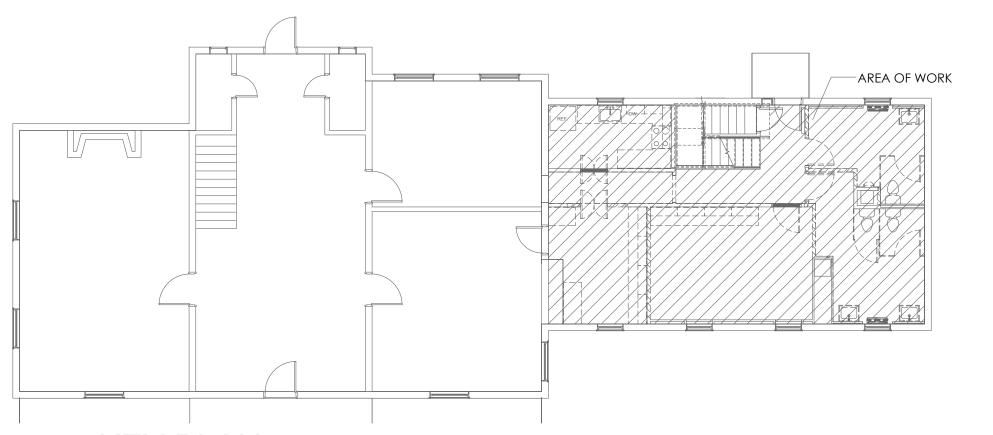
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RUST MANOR

802 CHILDRENS CENTER RD LEESBURG, VA 20175

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SCHEDULES AND DETAILS-PLUMBING

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SCALE:	
DATE:	



DEMOLITION FIRE ALARM PLAN

SCALE: 1/2" = 1'-0"

LEGEND

(D) TO BE DEMOLISHED (E) EXISTING TO REMAIN

(ER) EXISTING TO BE RELOCATED

F	IRE ALARM SYSTEM SYMBOLS
SYMBOL	DESCRIPTION
FACP	FIRE ALARM CONTROL PANEL (FACP) WITH BUILT-IN BACK-UP BATTERY UNITS.
75 A	COMBINATION FIRE ALARM AUDIO/VISUAL ADA TYPE SIGNALING DEVICE MOUNTED 6'-8" ABOVE FINISHED FLOOR OR AS NOTED. SUBSCRIPT NUMBER DENOTES CANDELA.
X ⁷⁵ X ⁷⁵	FIRE ALARM VISUAL ADA TYPE SIGNALING DEVICE MOUNTED ON CEILING OR 6'-8" ABOVE FINISHED FLOOR. SUBSCRIPT NUMBER DENOTES CANDELA.
A	FIRE ALARM AUDIO SIGNALING DEVICE MOUNTED 6-8" ABOVE FINISHED FLOOR.
F	FIRE ALARM MANUAL PULL STATION
(S) (S)	SURFACE MOUNT SMOKE DETECTOR

FIRE ALARM NOTES

- ALL FIRE ALARM DEVICES SHALL BE UL LISTED AND SHALL MEET REQUIREMENTS OF LOUDOUN COUNTY FIRE MARSHAL. INSTALLATION SHALL MEET FIRE MARSHAL REQUIREMENTS AND FOLLOWING STANDARDS: A.D.A, NEC 70, NFPA 72 AND LOCAL CODES.
- ALL WIRING FOR THE FIRE DETECTION SYSTEM AND FIRE ALARM DEVICES SUSCEPTIBLE TO DAMAGE SHALL BE RUN IN CONDUITS. ALL FIRE ALARM JUNCTION BOX COVERS SHALL BE PAINTED RED BY THE CONTRACTOR. ALL CONDUITS, DEVICES MOUNTING BOXES, JUNCTION BOXES AND PANELS SHALL BE SECURELY FASTENED BY THE CONTRACTOR WITH APPROPRIATE FITTINGS TO INSURE A POSITIVE GROUND THROUGHOUT THE ENTIRE SYSTEM.
- ALL WIRING SHALL BE CHECKED AND TESTED BY THE CONTRACTOR TO INSURE THE SYSTEMS IS FREE FROM GROUNDS, OPENS AND SHORT CIRCUITS.
- CONTRACTOR SHALL BE RESPONSIBLE TO PROVIDE ANY COMPONENTS AND/OR MAKE ANY MODIFICATIONS NECESSARY TO THE FIRE ALARM CONTROL PANEL AND BOOSTER POWER SUPPLY (POWER BATTERY) TO ALLOW FOR INSTALLATION OF NEW ADA APPROVED FIRE ALARM DEVICES. CONTRACTOR SHALL VISIT THE SITE AND EXAMINE CONDITIONS OF THE PREMISES AND THE CHARACTER AND EXTENT OF WORK REQUIRED PRIOR TO SUBMISSION OF BID.
- THE CONTRACTOR SHALL PREPARE ALL FIRE ALARM SYSTEM DRAWINGS INDICATING LOCATIONS OF ALL FIRE ALARM DEVICES FOR SUBMISSION AND APPROVAL BY LOCAL AUTHORITIES INCLUDING FIRE MARSHAL. THE PREPARED DRAWINGS BY THE CONTRACTOR SHALL BE THE SHOP DRAWINGS REQUIRED BY THE FIRE MARSHAL. THE CONTRACTOR SHALL BE RESPONSIBLE FOR PREPARATION OF AND ALL SUBMISSIONS OF FIRE ALARM SYSTEM DRAWINGS, THE SYSTEM SHALL INCLUDE, BUT NOT BE LIMITED TO THE FOLLOWING: ALARM INITIATING AND INDICATING PERIPHERAL DEVICES; OUTLET BOXES; CONDUIT; WIRE; AND ALL ACCESSORIES REQUIRED.
- 6. ALL SUBMITTALS SHALL BE SUBMITTED BY THE CONTRACTOR TO THE FIRE MARSHAL AND ARCHITECT FOR REVIEW.
- UPON COMPLETION, THE SYSTEM SHALL BE THOROUGHLY TESTED BY THE CONTRACTOR TO ASSURE PROPER INTERFACING OF ALL COMPONENTS.
- 8. THE FIRE ALARM SYSTEM SIGNALING DEVICES SHALL INCLUDE THE FOLLOWING: VISUAL AND AUDIO/VISUAL DEVICES SHALL BE IN ACCORDANCE WITH THE LOCAL JURISDICTION'S REGULATIONS AND THE ARCHITECT/ENGINEER'S DESIGNATION.
- UPON COMPLETION OF THE INSTALLATION AND AFTER SATISFACTORY TESTING OF THE SYSTEM BY THE CONTRACTOR IN THE PRESENCE OF THE EQUIPMENT SUPPLIER. THE CONTRACTOR SHALL TEST THE SYSTEM IN THE PRESENCE OF THE ARCHITECT/ENGINEER, FIRE MARSHALL, OWNER, AND OTHER AUTHORITIES HAVING JURISDICTION. THE MANUFACTURER SHALL FURNISH TO THE OWNER A ONE (1) YEAR CONTRACT EFFECTIVE FROM THE DATE OF ACCEPTANCE, FOR MAINTENANCE AND INSPECTION SERVICE OF THE MANUFACTURERS EQUIPMENT.
- 10. FIELD WIRING FOR EACH INTELLIGENT LOOP SHALL CONSIST OF CABLES FURNISHED AND INSTALLED BY THIS CONTRACTOR IN 1/2 INCH CONDUIT AS HEREIN SPECIFIED. THE TYPE, SIZE, AND NUMBER OF CONDUCTORS IN THE CABLE SHALL BE IN STRICT COMPLIANCE WITH THE MANUFACTURER'S REQUIREMENTS. FIELD WIRING FOR ALL ALARM SIGNALS SHALL BE COLOR CODED CONSISTING OF TWO (2) CONDUCTOR, NO. 12 A.W.G., SHIELDED, TWISTED PAIR CABLES FURNISHED AND INSTALLED BY THIS CONTRACTOR IN 1/2 INCH CONDUIT AS HEREIN SPECIFIED. WHERE REQUIRED, MAGNETIC DOOR HOLDER POWER WIRING FROM THE MAIN CONTROL PANEL SHALL CONSIST OF TWO (2) CONDUCTOR, NO. 12 A.W.G., TWISTED PAIR CABLES FURNISHED AND INSTALLED BY THIS CONTRACTOR IN 1/2 INCH CONDUIT AS HEREIN SPECIFIED.
- 1. COORDINATE SECURITY/SPACE ACCESS, FIRE SUPPRESSION SYSTEM AND SPRINKLER SYSTEM REQUIREMENTS WITH APPROPRIATE VENDORS.



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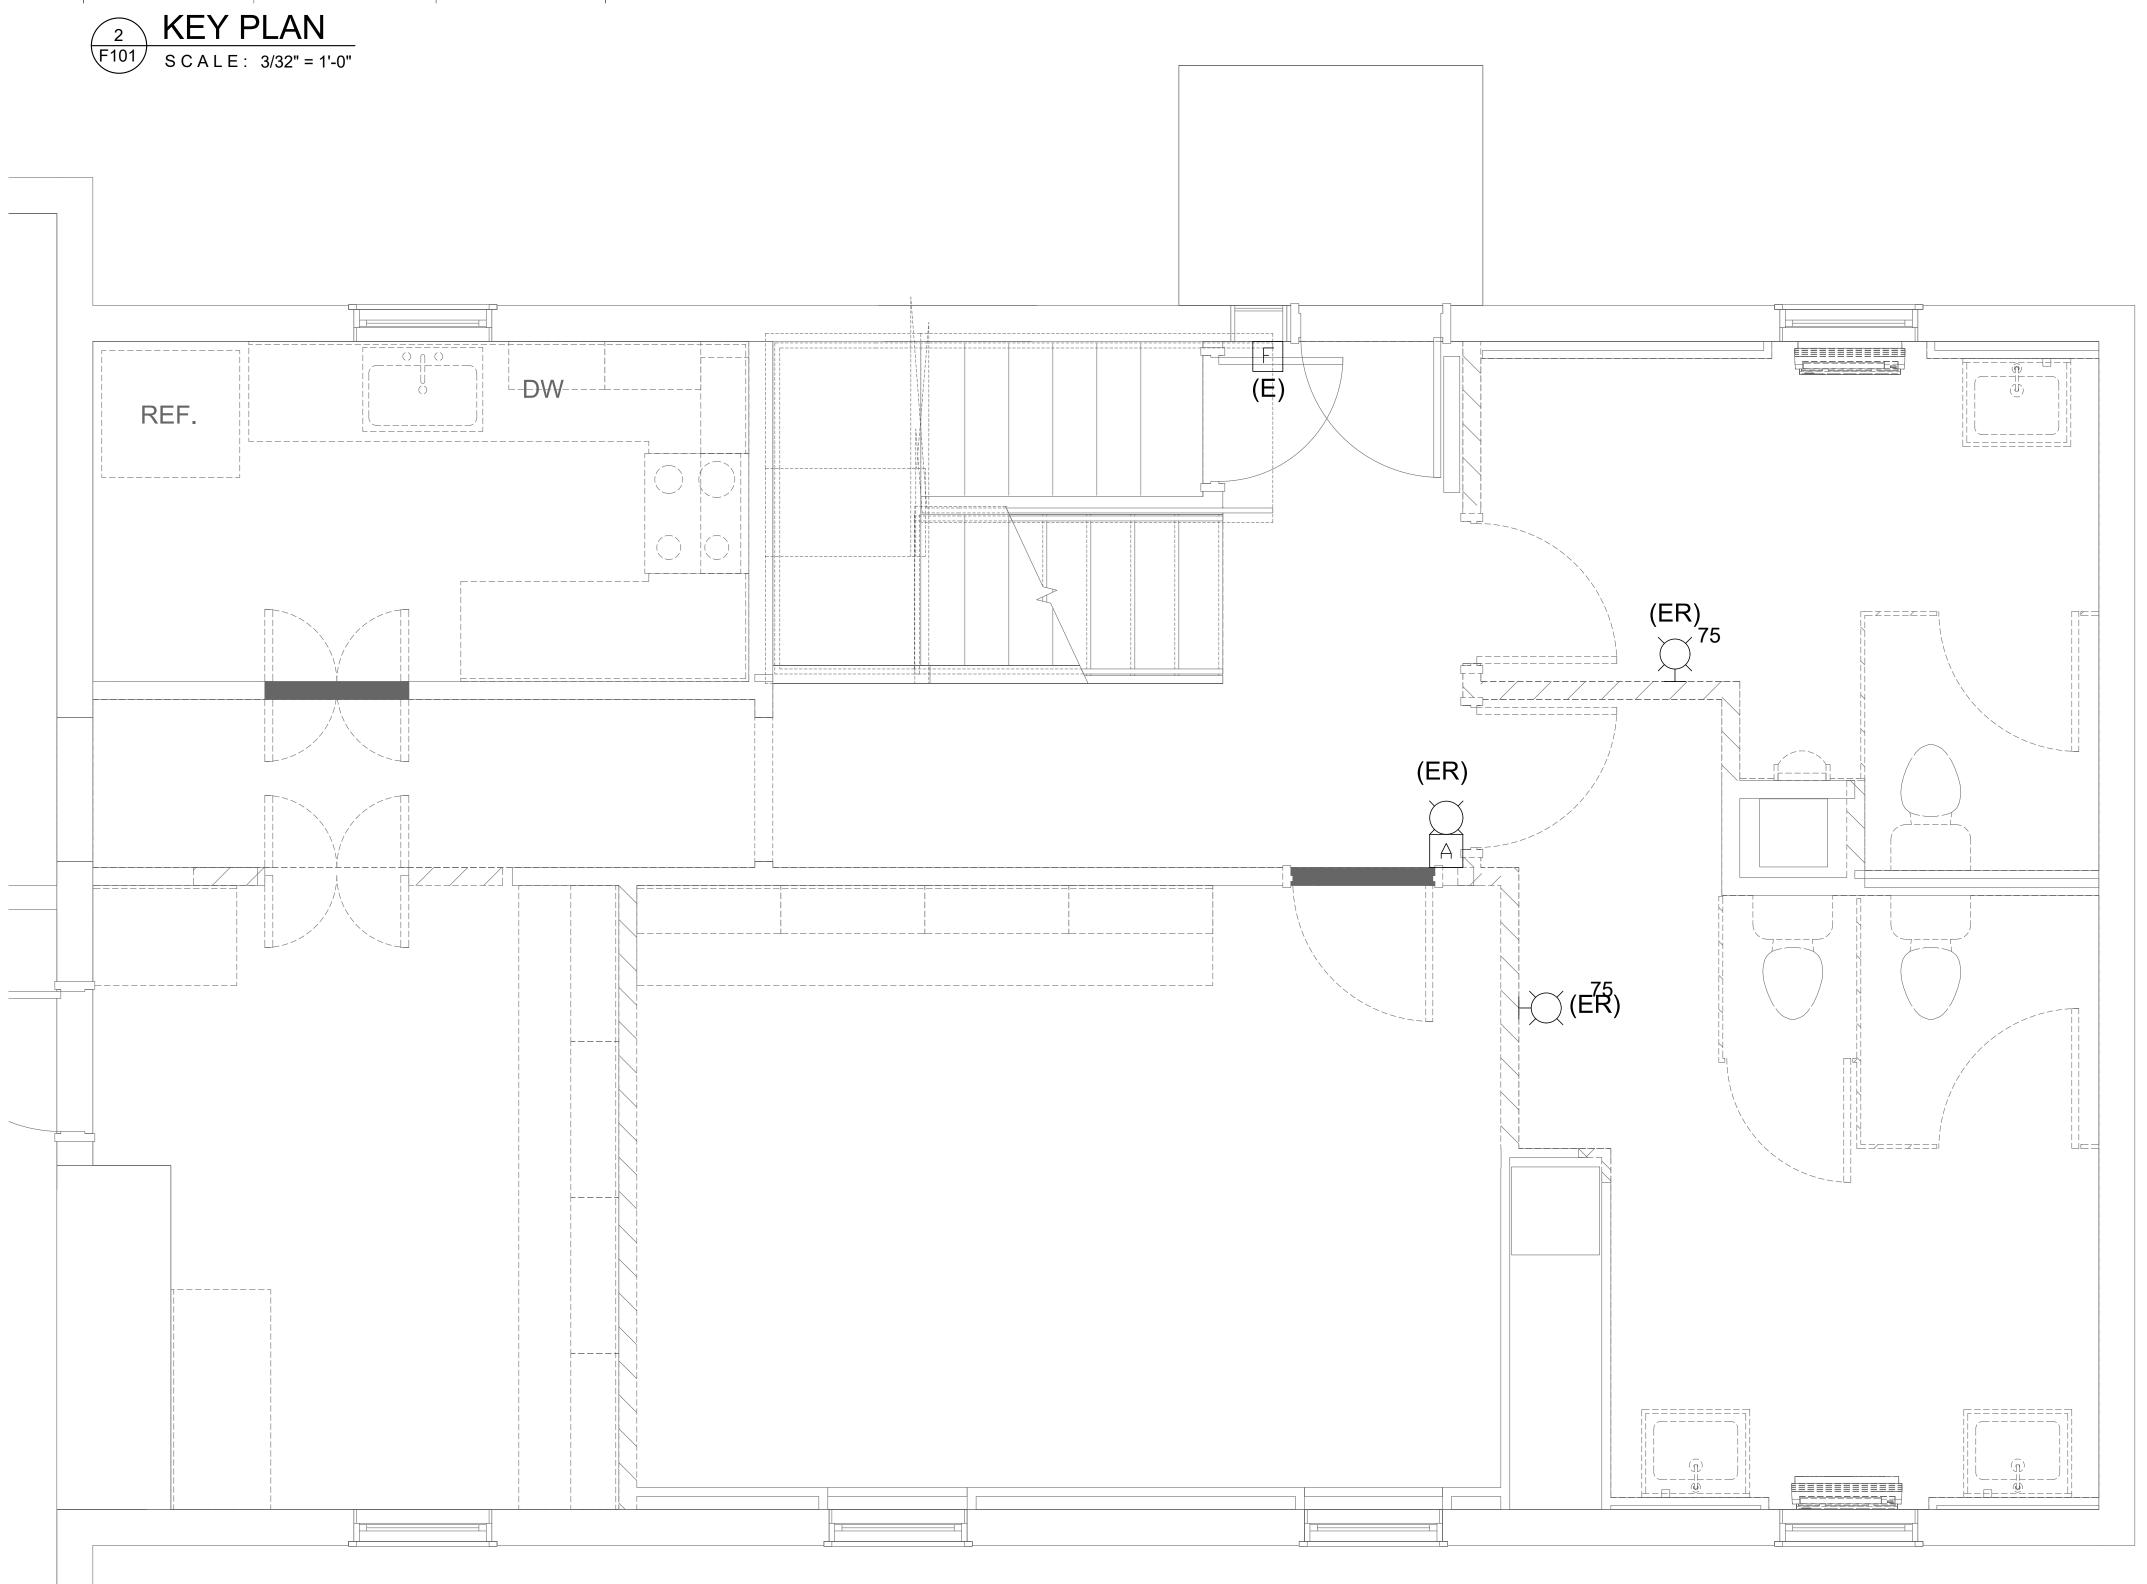
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DRAWING TITLE: FIRE ALARM NOTES, SYMBOLS AND DEMOLITION PLAN

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MEN'S RESTROOM 101 15 (N) **JANITOR** CLOSET 103 30 _≻ (N) PANTRY 15 (R) WOMEN'S 104 CEILING RESTROOM 102

NEW FIRE ALARM PLAN

F101 SCALE: 1/2" = 1'-0"

LEGEND

(N) NEW
(E) EXISTING TO REMAIN


(R) RELOCATED



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DRAWING TITLE: NEW FIRE ALARM DEMOLITION PLAN
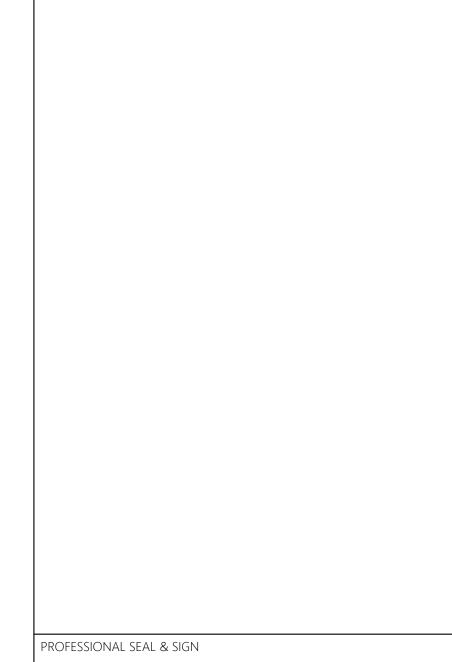
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CHECKED:	F101
SCALE:	
DATE:	